00 91 15 - 1 ADDENDUM NUMBER 6

SECTION 00 91 15

ADDENDUM NUMBER 6

PARTICULARS

1.01 DATE: APRIL 6, 2021

1.02 PROJECT: WELCOME CENTER

1.03 PROJECT NUMBER: DCM NO. 2020604

1.04 OWNER: ALABAMA A&M UNIVERSITY

1.05 ARCHITECT: NOLA | VAN PEURSEM ARCHITECTS, PC

TO PROSPECTIVE BIDDERS

- 2.01 THIS ADDENDUM FORMS A PART OF THE CONTRACT DOCUMENTS AND MODIFIES THE BIDDING DOCUMENTS DATED JANUARY 25, 2021, WITH AMENDMENTS AND ADDITIONS NOTED BELOW.
- 2.02 ACKNOWLEDGE RECEIPT OF THIS ADDENDUM IN THE SPACE PROVIDED IN THE PROPOSAL FORM. FAILURE TO DO SO MAY DISQUALIFY THE BIDDER.
- 2.03 THIS ADDENDUM CONSISTS OF 27 PAGES.

CHANGES TO THE PROJECT MANUAL

- 3.01 APPROVED EQUALS, these approvals are based solely upon the manufacturers meeting all conditions of drawings and specifications presently set.
 - A. Section 04 72 00 -Cast Stone Masonry: Olde World Cast Stone.
 - B. Section 07 90 05 Joint Sealers:
 - 1. Sika USA, for Types 1, 4, 5, & 6.
 - 2. EMSEAL, for Type 2.

3.02 SECTION 00 10 00-BID DOCUMENTS AND FORMS:

A. Advertisement for Bid: Revise Bid Date to read, "April 15, 2021".

3.03 SECTION 00 22 00-OWNER'S SUPPLEMENTARY INSTRUCTIONS TO BIDDERS:

A. Paragraph 1.03.B: Revise paragraph to read as follows, "All sealed bids will be received by 2:00 p.m. CDT on *April 15, 2021* at which time each bidder must submit a sealed envelope properly titled containing the Proposal form, the Bid Bond, Accounting of Sales Tax - DCM Form C-3A form, and Affidavit A. Upon receipt of these documents the bids will be publicly opened and read aloud. Supplement A – List of Subcontractors (section 00 43 21) and Affidavit C are to be hand delivered or emailed to the Architect within 24 hours after receipt of bids. No changes to the base bid will be allowed after 2:00 p.m."

3.04 SECTION 01 21 00 - ALLOWANCES:

A. Paragraph 1.05.F – Revise paragraph to read as follows, "Include the stipulated sum of \$36,000 for interactive displays and TVs including all replated parts, mounting hardware, labor and installation."

3.05 SECTION 09 51 00 -ACCOUSTICAL CEILINGS:

A Paragraph 2.02.D.6 – Revise paragraph to read as follows, "Product: Woodworks Tegular by Armstrong World Industries, Inc."

3.06 SECTION 22 42 10 -PLUMBING FIXTURES:

A. Paragraph 2.02.P-24 – Revise paragraph to read as follows, "Hydraulic Oil Interceptor: Zurn Fog-Ceptor model Z250-MH single tank underground fiberglass assembly with 250 gallon liquid capacity with 100 GPM rated flow. Tank shall be provided with two factory access manways to grade, cast iron manhole frame with grate cover for H20 traffic loading and 4" inlet and outlet connections. Tank shall be installed in accordance with the factory installation procedures, including but not limited to an approved gravel base, 18" deep concrete anti-floatation pad, approved sand or pea gravel backfill, reinforced top concrete pad at the manways and manhole frame and lids as detailed on the drawings. Exterior edge of the pad shall extend a minimum of 12" past the overall edge of the tanks with the top of the pad flush with the floor. Vents to be connected and routed per manufacturer's recommendations and as indicated on the drawings. The tank assembly shall be reinforced and rated for deep bury. The tank assembly shall be provided with a SmartPro RF wireless monitoring and alarm system to monitor the grease and solids level in the tank. See details on the drawing for additional information and installation requirements."

3.07 SECTION 26 85 00 - VIDEO SURVEILLANCE SYSTEM:

- A. Clarification: All cameras, camera licenses, additional servers and/ or storage to be furnished and installed by allowance. Final camera integration into existing system to be by owner, N.I.C.
- B. No cameras, camera licenses, video management servers, video surveillance file storage are to be included in bid price (other than by the allowance noted above).

3.08 SECTION 26 96 10 - DINING AV SYSTEMS:

- A. Clarification: This section is mislabeled in the project manual as 26 77 00. Revise this number to read 26 96 10.
- B. Rename this section as follows: "Audio Visual System".
- C. Section 2.3, Conference 108, Video: Delete two (2) each Vivitek 86" Novotouch interactive displays and two (2) each Chief XTM1U mounts. This display and its associated mount will be furnished and installed by allowance.
- D. Section 2.3, Conference 202, Video: Delete one (1) each Vivitek 86" Novotouch interactive display and one (1) each Chief XTM1U mount. This display and its associated mount will be furnished and installed by allowance.

CHANGES TO THE DRAWINGS

4.01 SHEET C501 - STORM DRAIN PLAN:

- A. Replace this Sheet in its Entirety. Revisions include the following:
 - 1. Modified 12" HDPE invert in AI-31.
 - 2. Modified slope of 12" HDPE storm pipe P36-31.
 - 3. Modified inverts in AI-36.
 - 4. Modified length & slope of 12" HP storm pipe P37-36.
 - 5. Modified invert in AI-37.
 - 6. Added 6" PVC foundation drainpipe from elevator sump to connect to P37-36.
 - 7. Added 6" In line Check Valve in outfall end of 6" PVC foundation drain.
 - 8. Added Detail 1/C501 -In Line Storm Drain Cheek Valve.
 - 9. Modified top elevation of AI-33.

4.02 SHEET C701 - UTILITY PLAN:

- A. Replace this Sheet in its Entirety. Revisions include the following:
 - 1. Changed to show that the public fire hydrant material & installation is by Huntsville Utilities.
 - Change the connection point for the private fire hydrant line to be on the building side of the Fire Vault.
 - 3. Changed the route of the private fire hydrant line at the fire vault.

4.03 SHEET C803 - CONSTRUCTION DETAILS:

- A. Replace this Sheet in its Entirety. Revisions include the following:
 - 1. Modified Detail 7/803-Fire Main Connection Detail to show the public fire hydrant material & installation is by Huntsville Utilities.
 - 2. Change the connection point for the private fire hydrant line.
 - 3. Clarified that the contractor shall provide and install all materials required for the private fire hydrant line and fire hydrant as shown on sheet C701.

4.04 SHEET C804 - CONSTRUCTION DETAILS:

- A. Replace this Sheet in its Entirety. Revisions include the following:
 - 1. Modified Detail 13/804-Revise the fence to be shadowbox type.

4.05 SHEET L-1.1 - HARDSCAPE PLAN:

A. Detail 3/L-1.1: Revise note on this detail to read as follows:

Bega 36-inch Bollard, 84016-71 125

System Bollard Tube with Drive-through protection

System Bollard Head, Non-illuminated cap

No wiring is needed.

4.06 ALL ARCHITECTURAL SHEETS:

A. Clarification: Where weather barrier is shown over continuous rigid insulation, revise the weather barrier to be located over the exterior sheathing.

4.07 SHEET A-1.3 - FIRST FLOOR PLAN:

- A. Replace this sheet in its entirety. Revisions include the following:
 - 1. Revise width of elevator shaft

4.08 SHEET A-1.4 - SECOND FLOOR PLAN:

- A. Replace this sheet in its entirety. Revisions include the following:
 - 1. On Column Details 3/ A1.4: Change the note identifying the glass to read "1-inch insulated glass".
 - On Column Detail 7/ A-1.4: Change the note which reads "Weather barrier over cont. rigid insulation over 8" CMU" to read "Cont. Rigid Insulation over bituminous dampproofing over 8" CMU".
 - 3. On Column Detail 8/ A-1.4: Revise the dimensions which read "8 ½ inches" to read "6 ½ inches".
 - 4. Revise width of elevator shaft.

4.09 SHEET A-4.1 - ROOM FINISH SCHEDULE:

- A. Revise the Room Finish Schedule as follows:
 - 1. At Rooms 106 MEN and 107 Women: Change the scheduled finish for all walls to be "PT-1/GBEP".
 - 2. At Rooms 106 MEN and 107 Women: Add the following note under Remarks: "See Sheet A-6.1 for extent of wall tile."

4.10 SHEET A-5.3 - CURTAINWALL ELEVATIONS:

- A. Replace this sheet in its entirety. Revisions include the following:
 - 1. Adjusted dimensions on curtain wall elevations.

4.11 SHEET A-5.4 - STOREFRONT ELEVATIONS & DETAILS:

- A. Replace this sheet in its entirety. Revisions include the following:
 - 1. Revised details.

4.12 SHEET A-5.5 - CURTAINWALL DETAILS:

- A. Replace this sheet in its entirety. Revisions include the following:
 - 1. Adjusted dimensions and notes on curtain wall details.
 - 2. Added EIFS details.

4.13 SHEET A-7.1 - WALL SECTIONS:

- A. Replace this sheet in its entirety. Revisions include the following:
 - 1. Updated notes regarding weather barrier, mortar nets, and flashing.
 - 2. Updated exterior wall construction at second floor slab.

4.14 SHEET A-7.2 - WALL SECTIONS:

- A. Replace this sheet in its entirety. Revisions include the following:
 - 1. Updated notes regarding weather barrier, EIFS.
 - 2. Updated exterior wall construction at second floor slab.

4.15 SHEET A-7.3 - WALL SECTIONS:

- A. Replace this sheet in its entirety. Revisions include the following:
 - 1. Updated notes regarding weather barrier, mortar net, and vapor barrier.

4.16 SHEET A-7.4 - WALL SECTIONS:

- A. Replace this sheet in its entirety. Revisions include the following:
 - 1. Updated notes regarding weather barrier, mortar net, and flashing.

4.17 SHEET A-9.1 - CANOPY DETAILS:

- A. Revise this sheet as follows:
 - 1. On the canopy section 2/A-9.0, revise note reading "1/2" sheathing over 6" mtl studs @ 16" O.C" to read: "Weather barrier over 1/2" sheathing over 6" mtl studs @ 16" O.C.".

4.18 SHEET S-1.0 - FOUDNATION PLAN:

- A. Replace this sheet in its entirety. Revisions include the following:
 - 1. Added hatch denoting area of recessed slab.
 - 2. Revised dimensions at elevator pit.

4.19 SHEET S-1.0A - SLAB ON GRADE PLAN:

- A. Replace this sheet in its entirety. Revisions include the following:
 - 1. Added hatch denoting area of recessed slab.
 - 2. Revised dimensions at elevator pit.

4.20 SHEET S-1.1 - FLOOR FRAMING AND LOW ROOF FRAMING PLAN:

- A. Replace this sheet in its entirety. Revisions include the following:
 - 1. Added section marks for details J/S-3.1 and K/S-3.1.
 - 2. Added missing beam designation.

4.21 SHEET S-1.2 - ROOF FRAMING PLAN:

- A. Replace this sheet in its entirety. Revisions include the following:
 - 1. Revised notes around the elevator shaft.

4.22 SHEET S-3.0 - FOUNDATION SECTIONS:

- A. Replace this sheet in its entirety. Revisions include the following:
 - 1. Revised dimensions around the elevator pit on detail K/S-3.0
 - 2. Revised dimensions on details

4.23 SHEET S-3.1 – WALL SECTIONS:

- A. Replace this sheet in its entirety. Revisions include the following:
 - 1. Added Sections J/S-3.1 & K/S-3.1.
 - 2. Revised dimensions on detail F/S-3.1
 - 3. Added contractor's option to use beams at Section H/S-3.1

4.24 SHEET M-3.1 - MECHANICAL SCHEDULES:

- A. Revise this sheet as follows:
 - 1. On RTU Schedule (DX/Gas) add accessory 14 as listed below.
 - 14. Provide factory fabricated 18" high roof curb with sound blanket, through the base electrical and thermal insulation. Unit and curb assembly shall be in compliance with IBC 1609 Wind Load. Submit factory installation details sealed and signature and date by the manufacturer's compliance engineer. See Mechanical Devices and Notes for additional requirements.


4.25 SHEET E-1.0 - WALL SECTIONS:

- A. Replace this sheet in its entirety. Revisions include the following:
 - 1. Security legend has been revised. See attached revised drawings.
 - 2. Add descriptions for ceiling speaker and ceiling subwoofer. See attached revised drawings.
 - 3. New fire alarm system (fire alarm control panel, fire alarm devices, fire alarm cabling, fire alarm system set-up and programming) to be furnished and installed under base bid. See attached revised drawings.

4.26 SHEET E-3.0 - ELECTRICAL SINGLE LINE DIAGRAMS:

- A. Replace this sheet in its entirety. Revisions include the following:
 - 1. Added note to show new utility transformer to be fed from new riser pole.

END OF ADDENDUM NUMBER 6

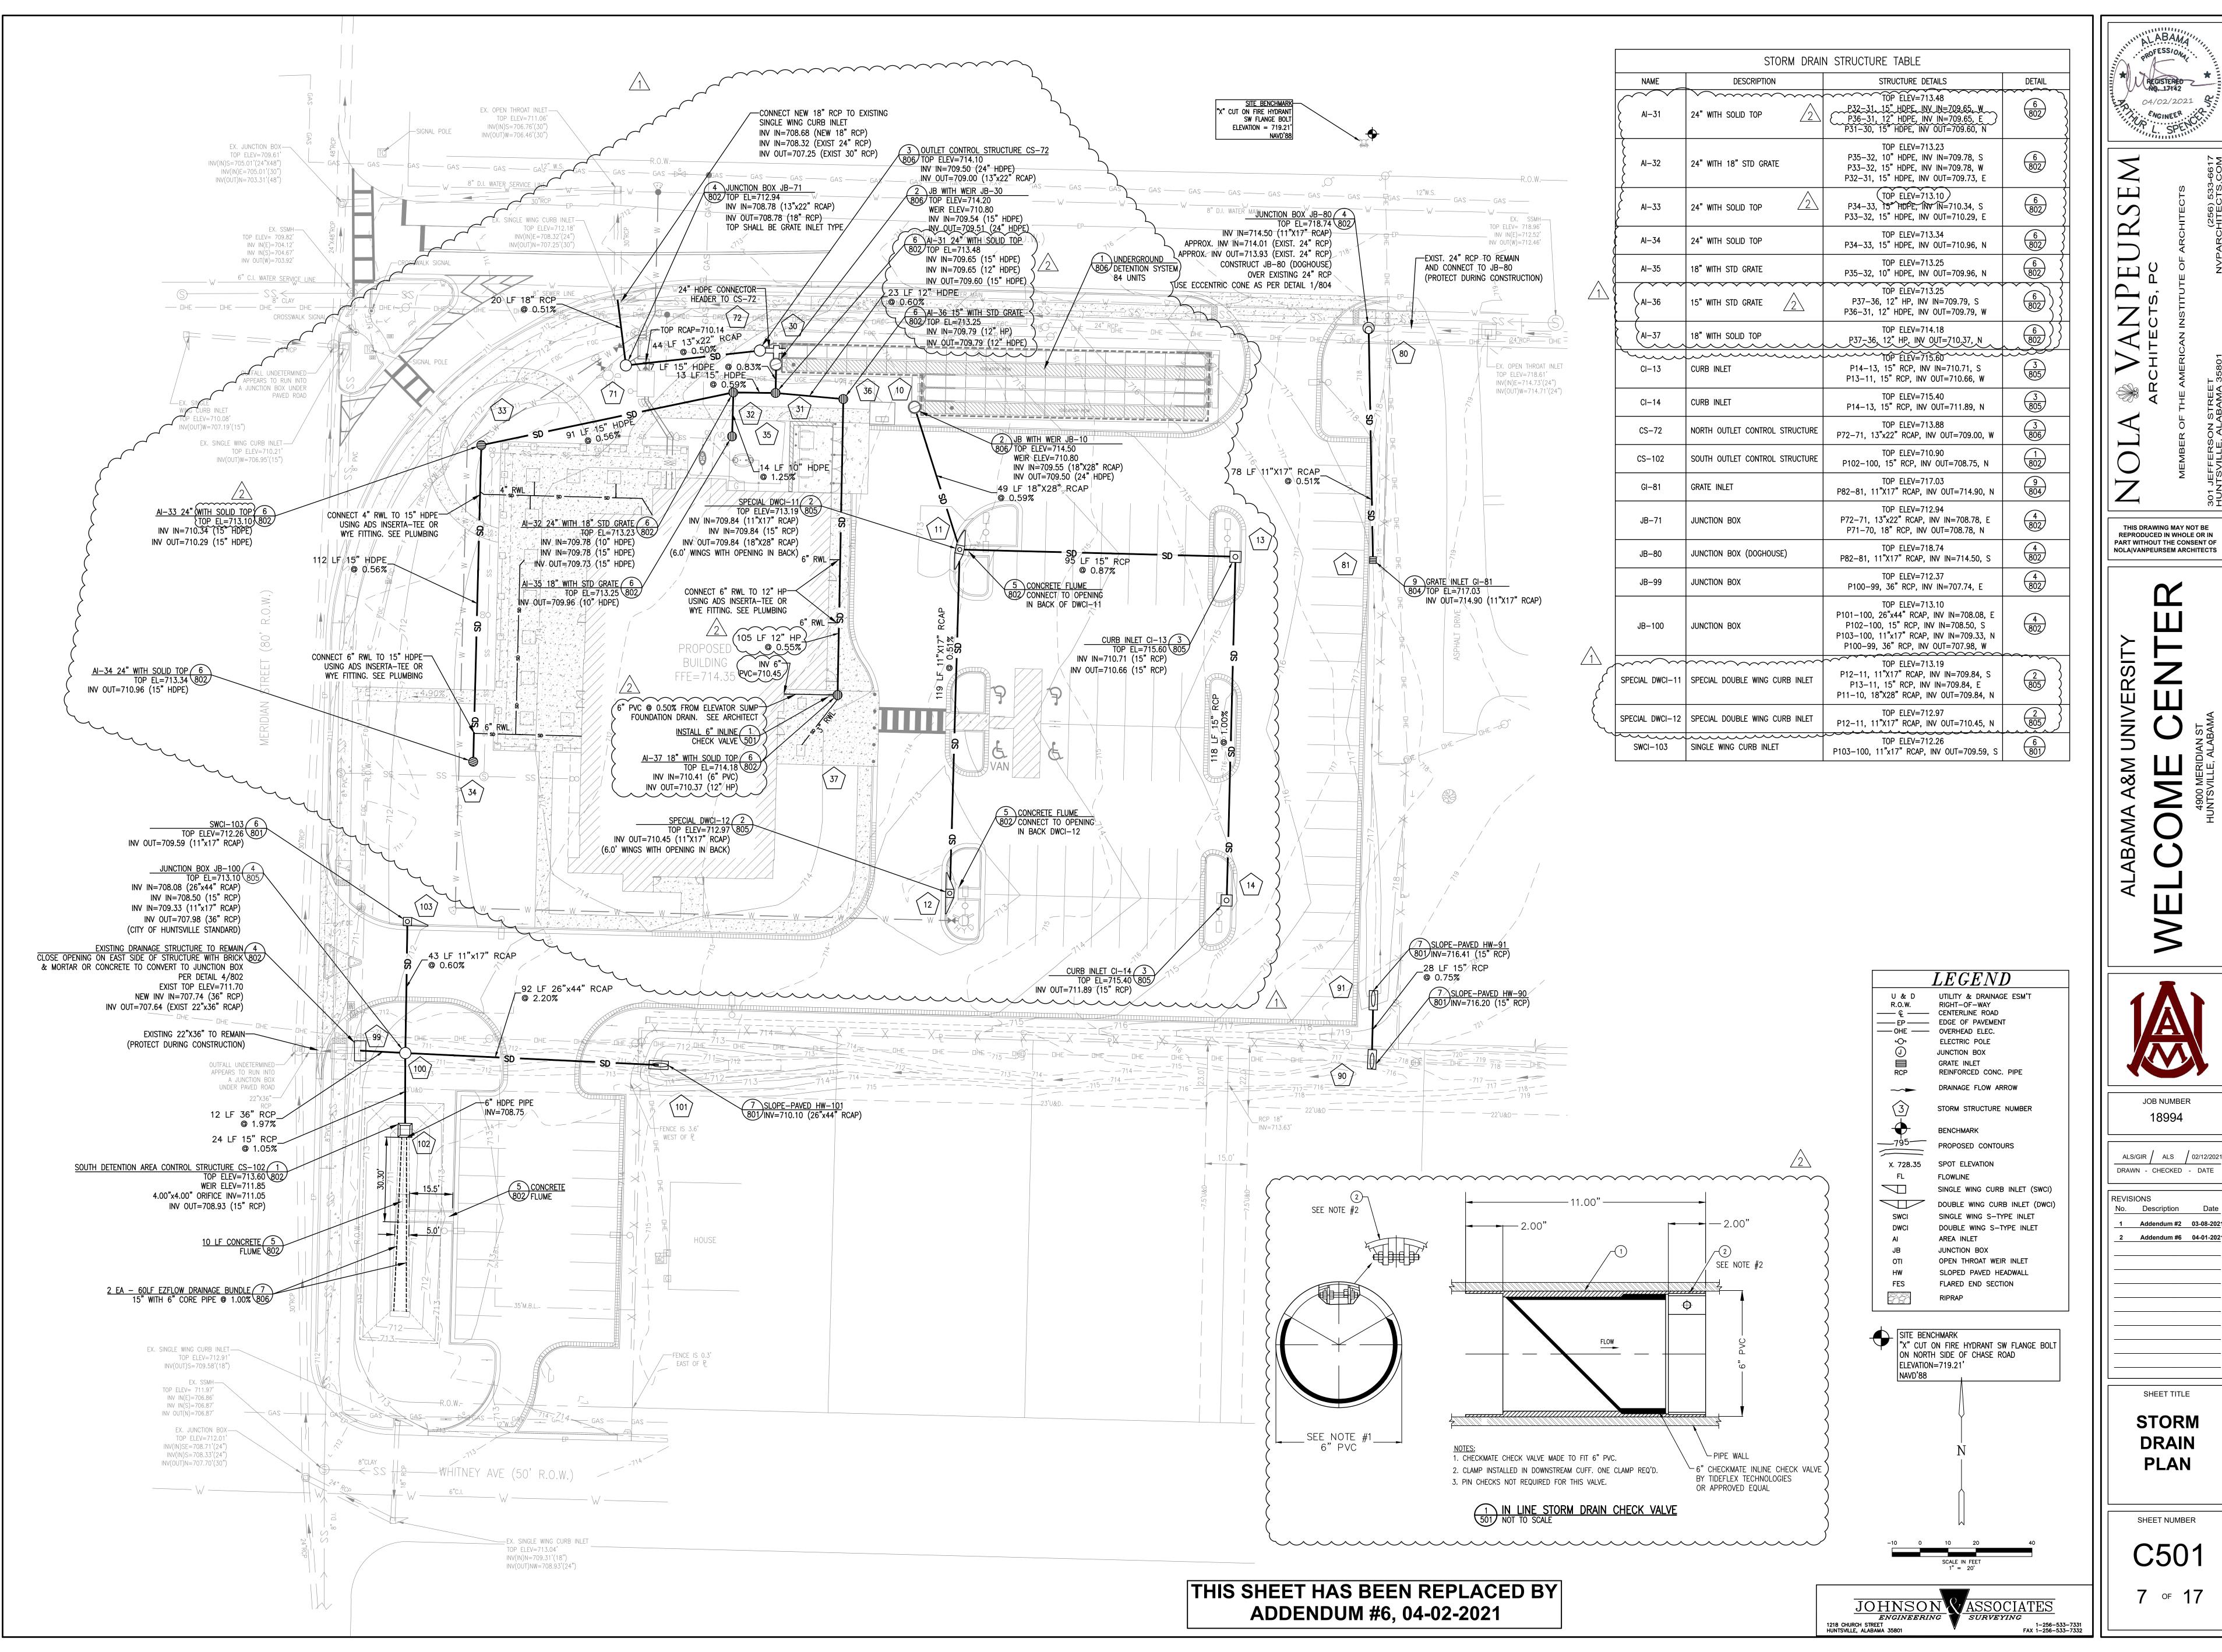

ALABAMA" REGISTERED NO. 17142 04/02/2021 ENGINEER.

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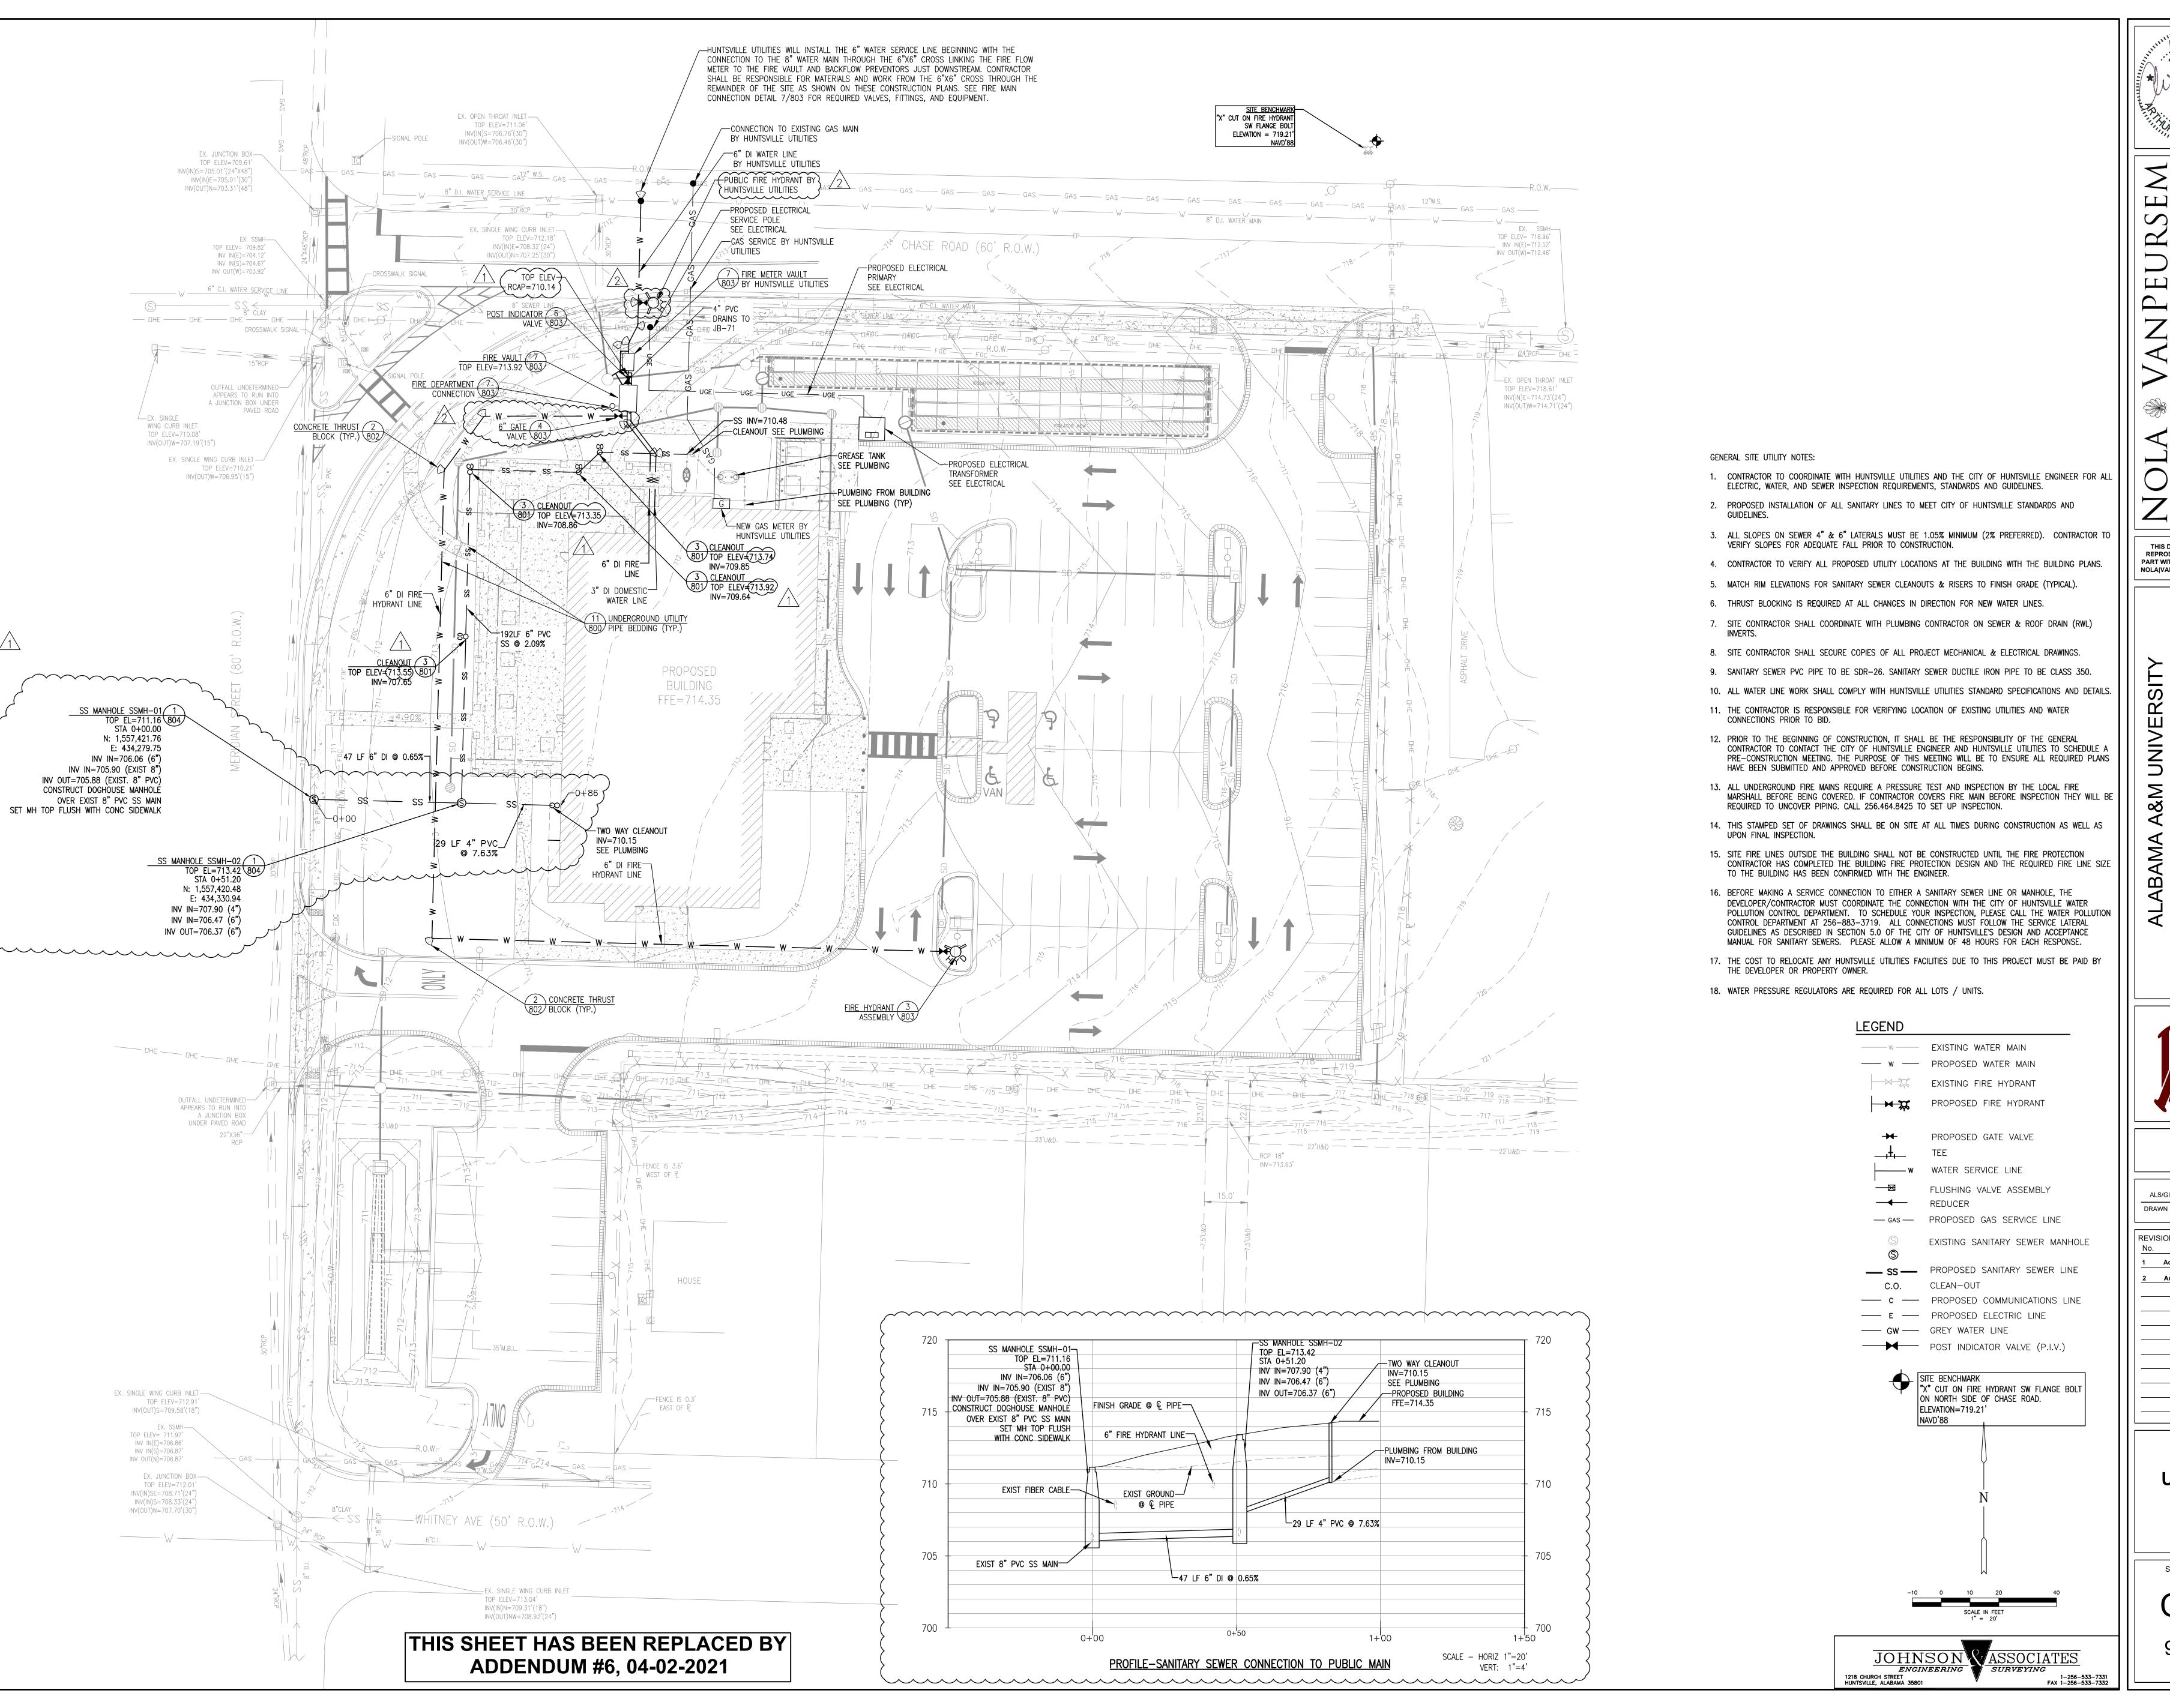
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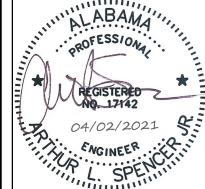
Addendum #2 03-08-2021 Addendum #6 04-01-202

SHEET TITLE **STORM** DRAIN **PLAN**

SHEET NUMBER

of 17





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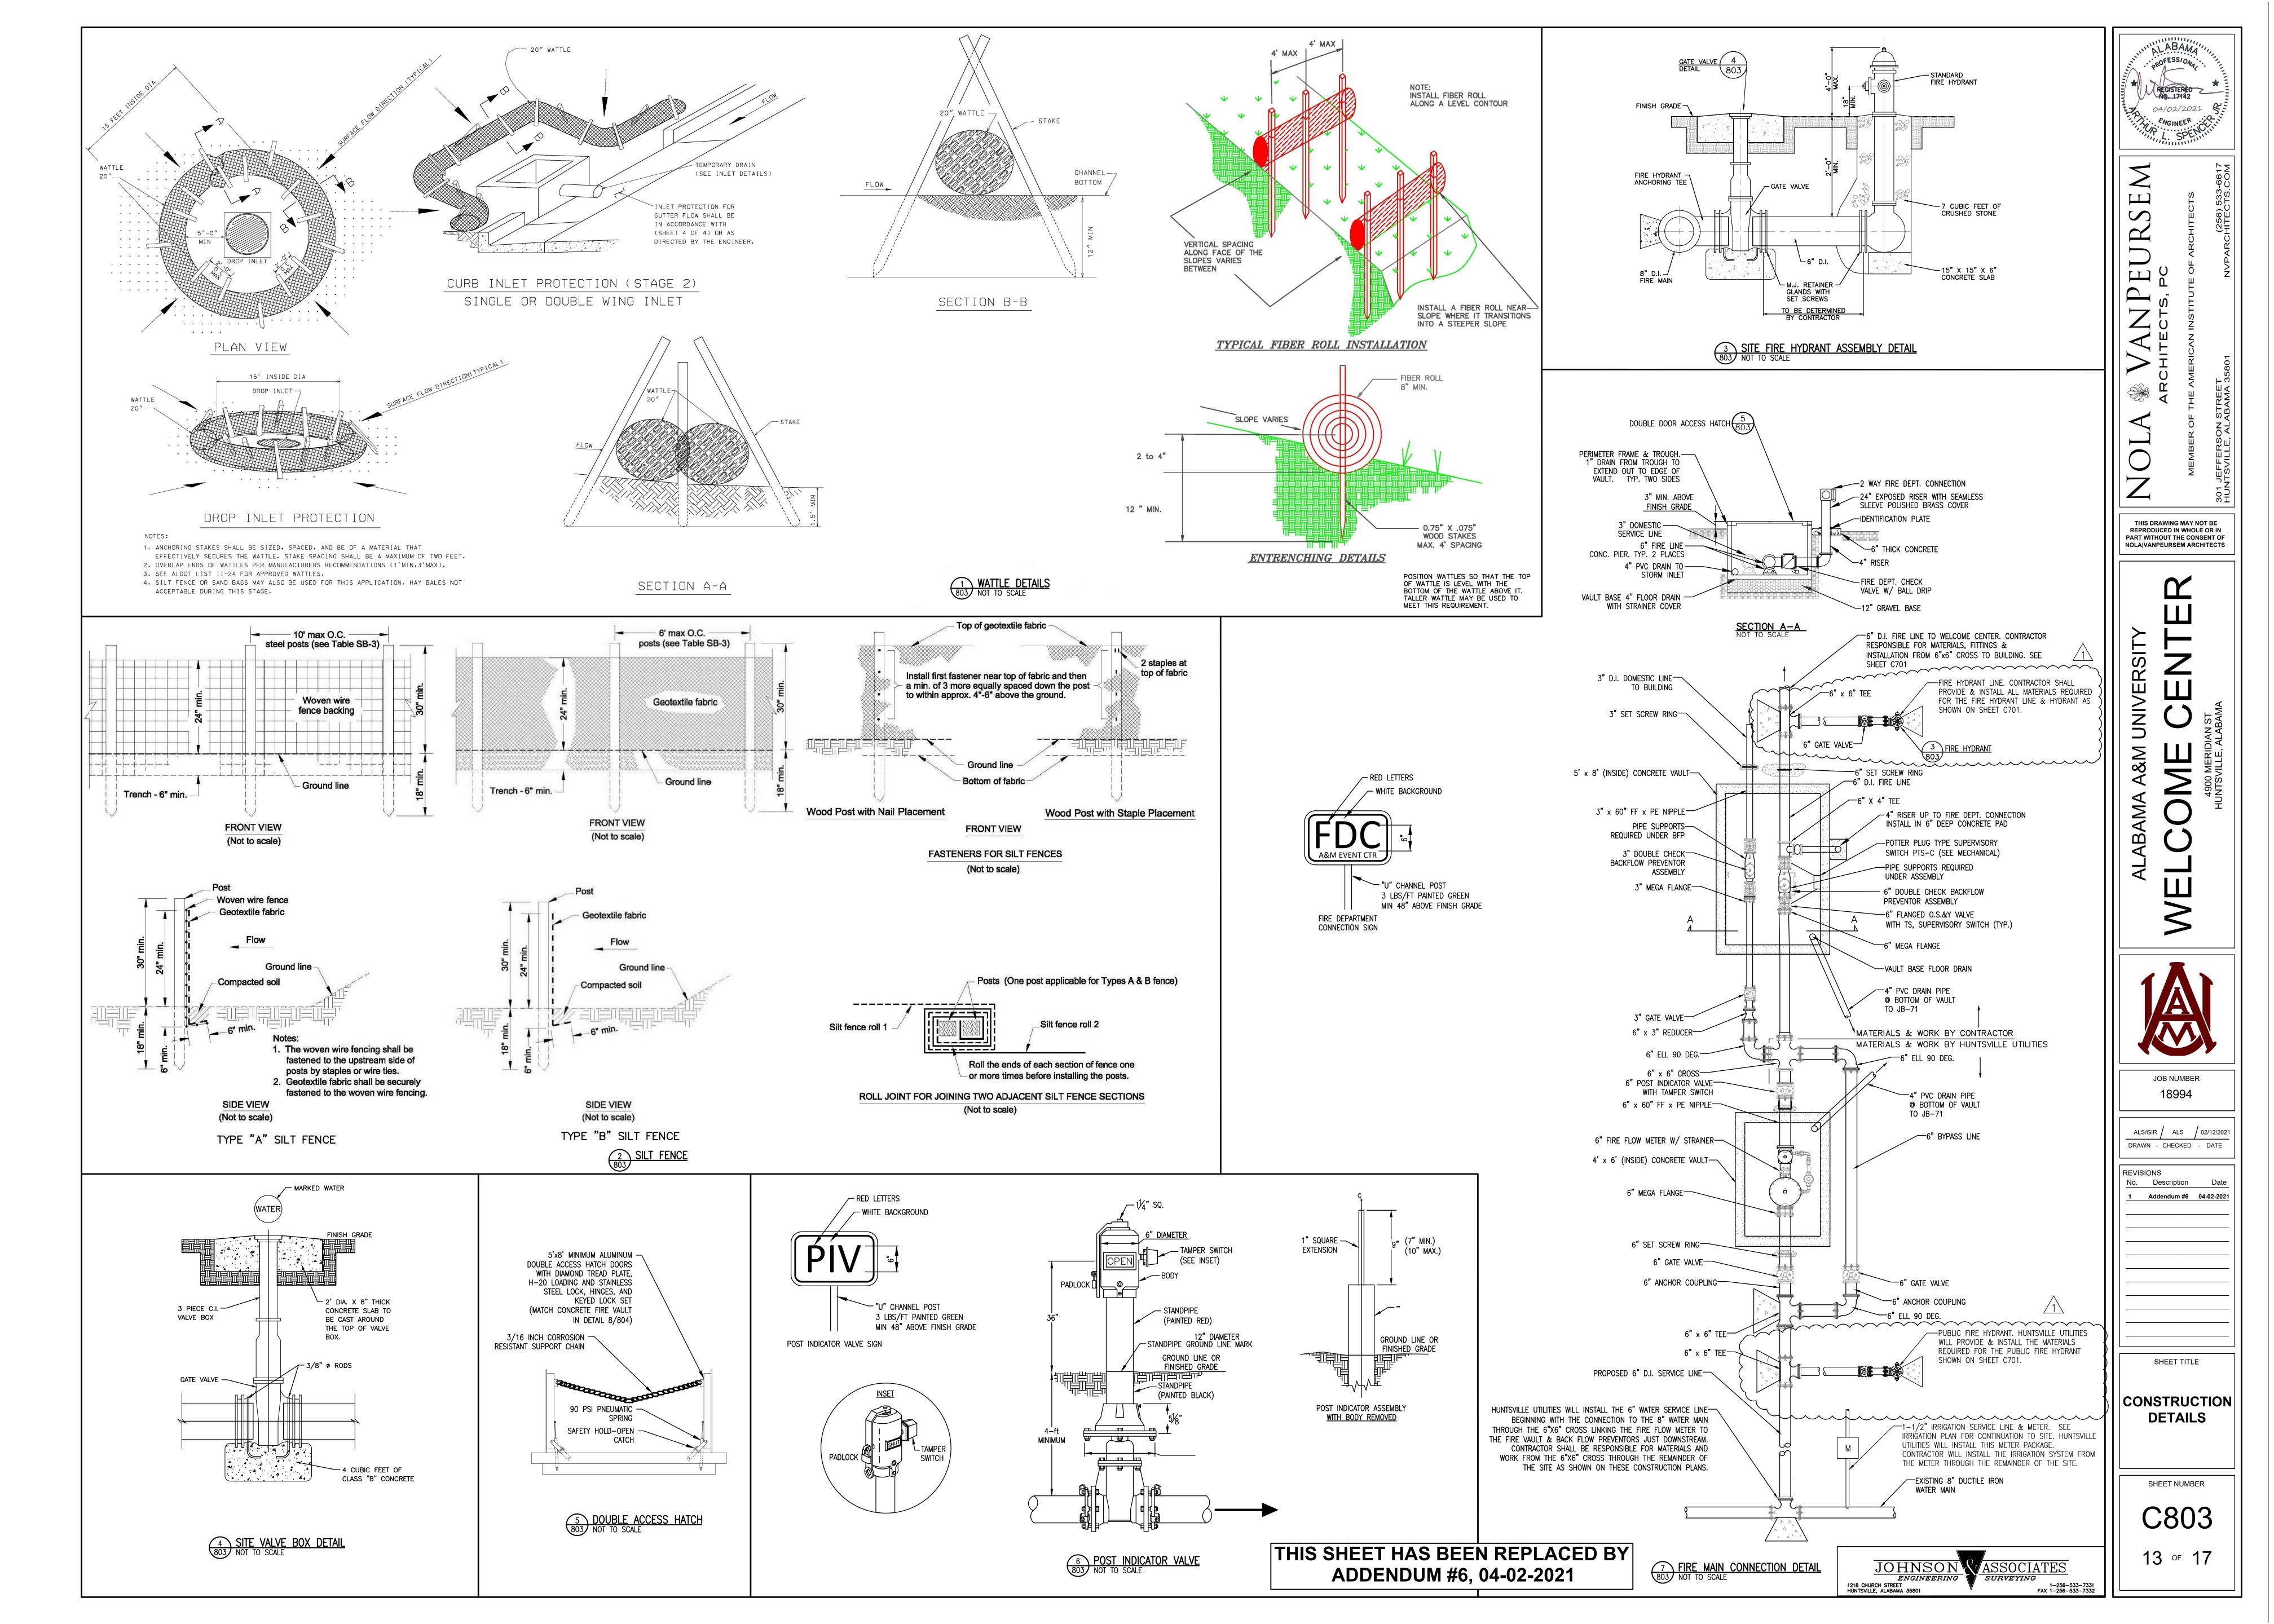
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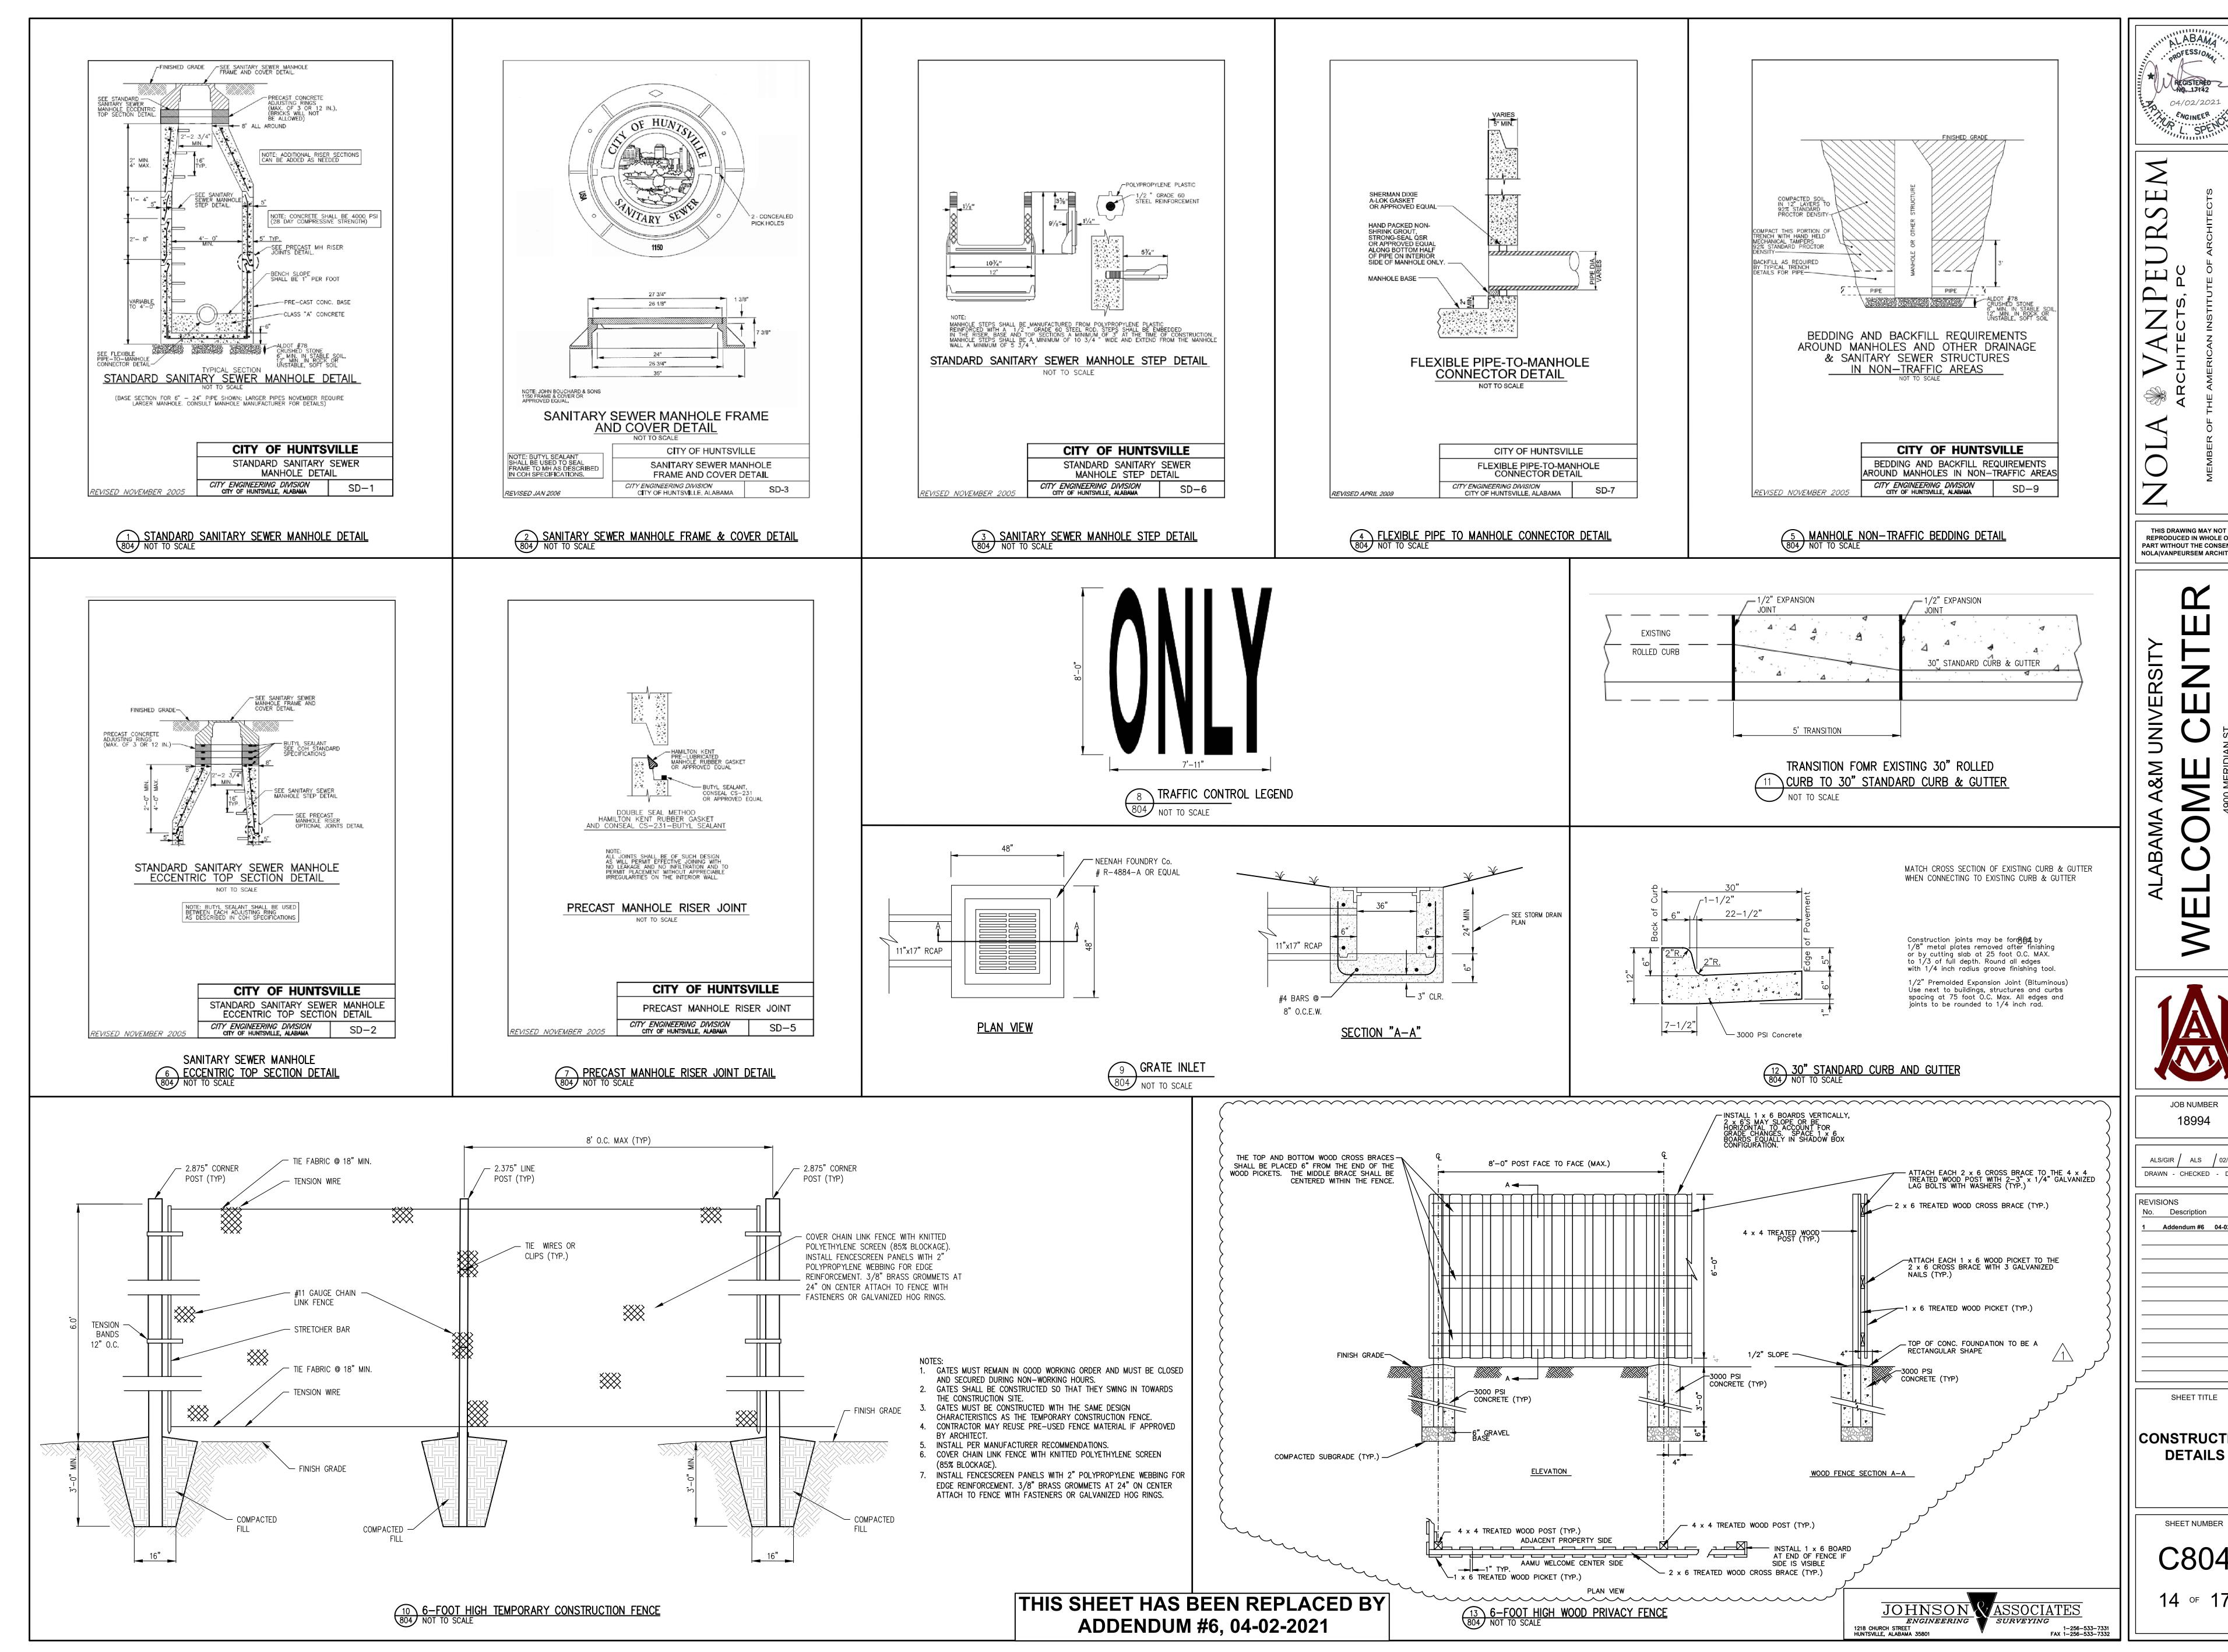
Addendum #2 03-08-2021 Addendum #6 04-02-2021

UTILITY **PLAN**

SHEET NUMBER C701

9 of 17





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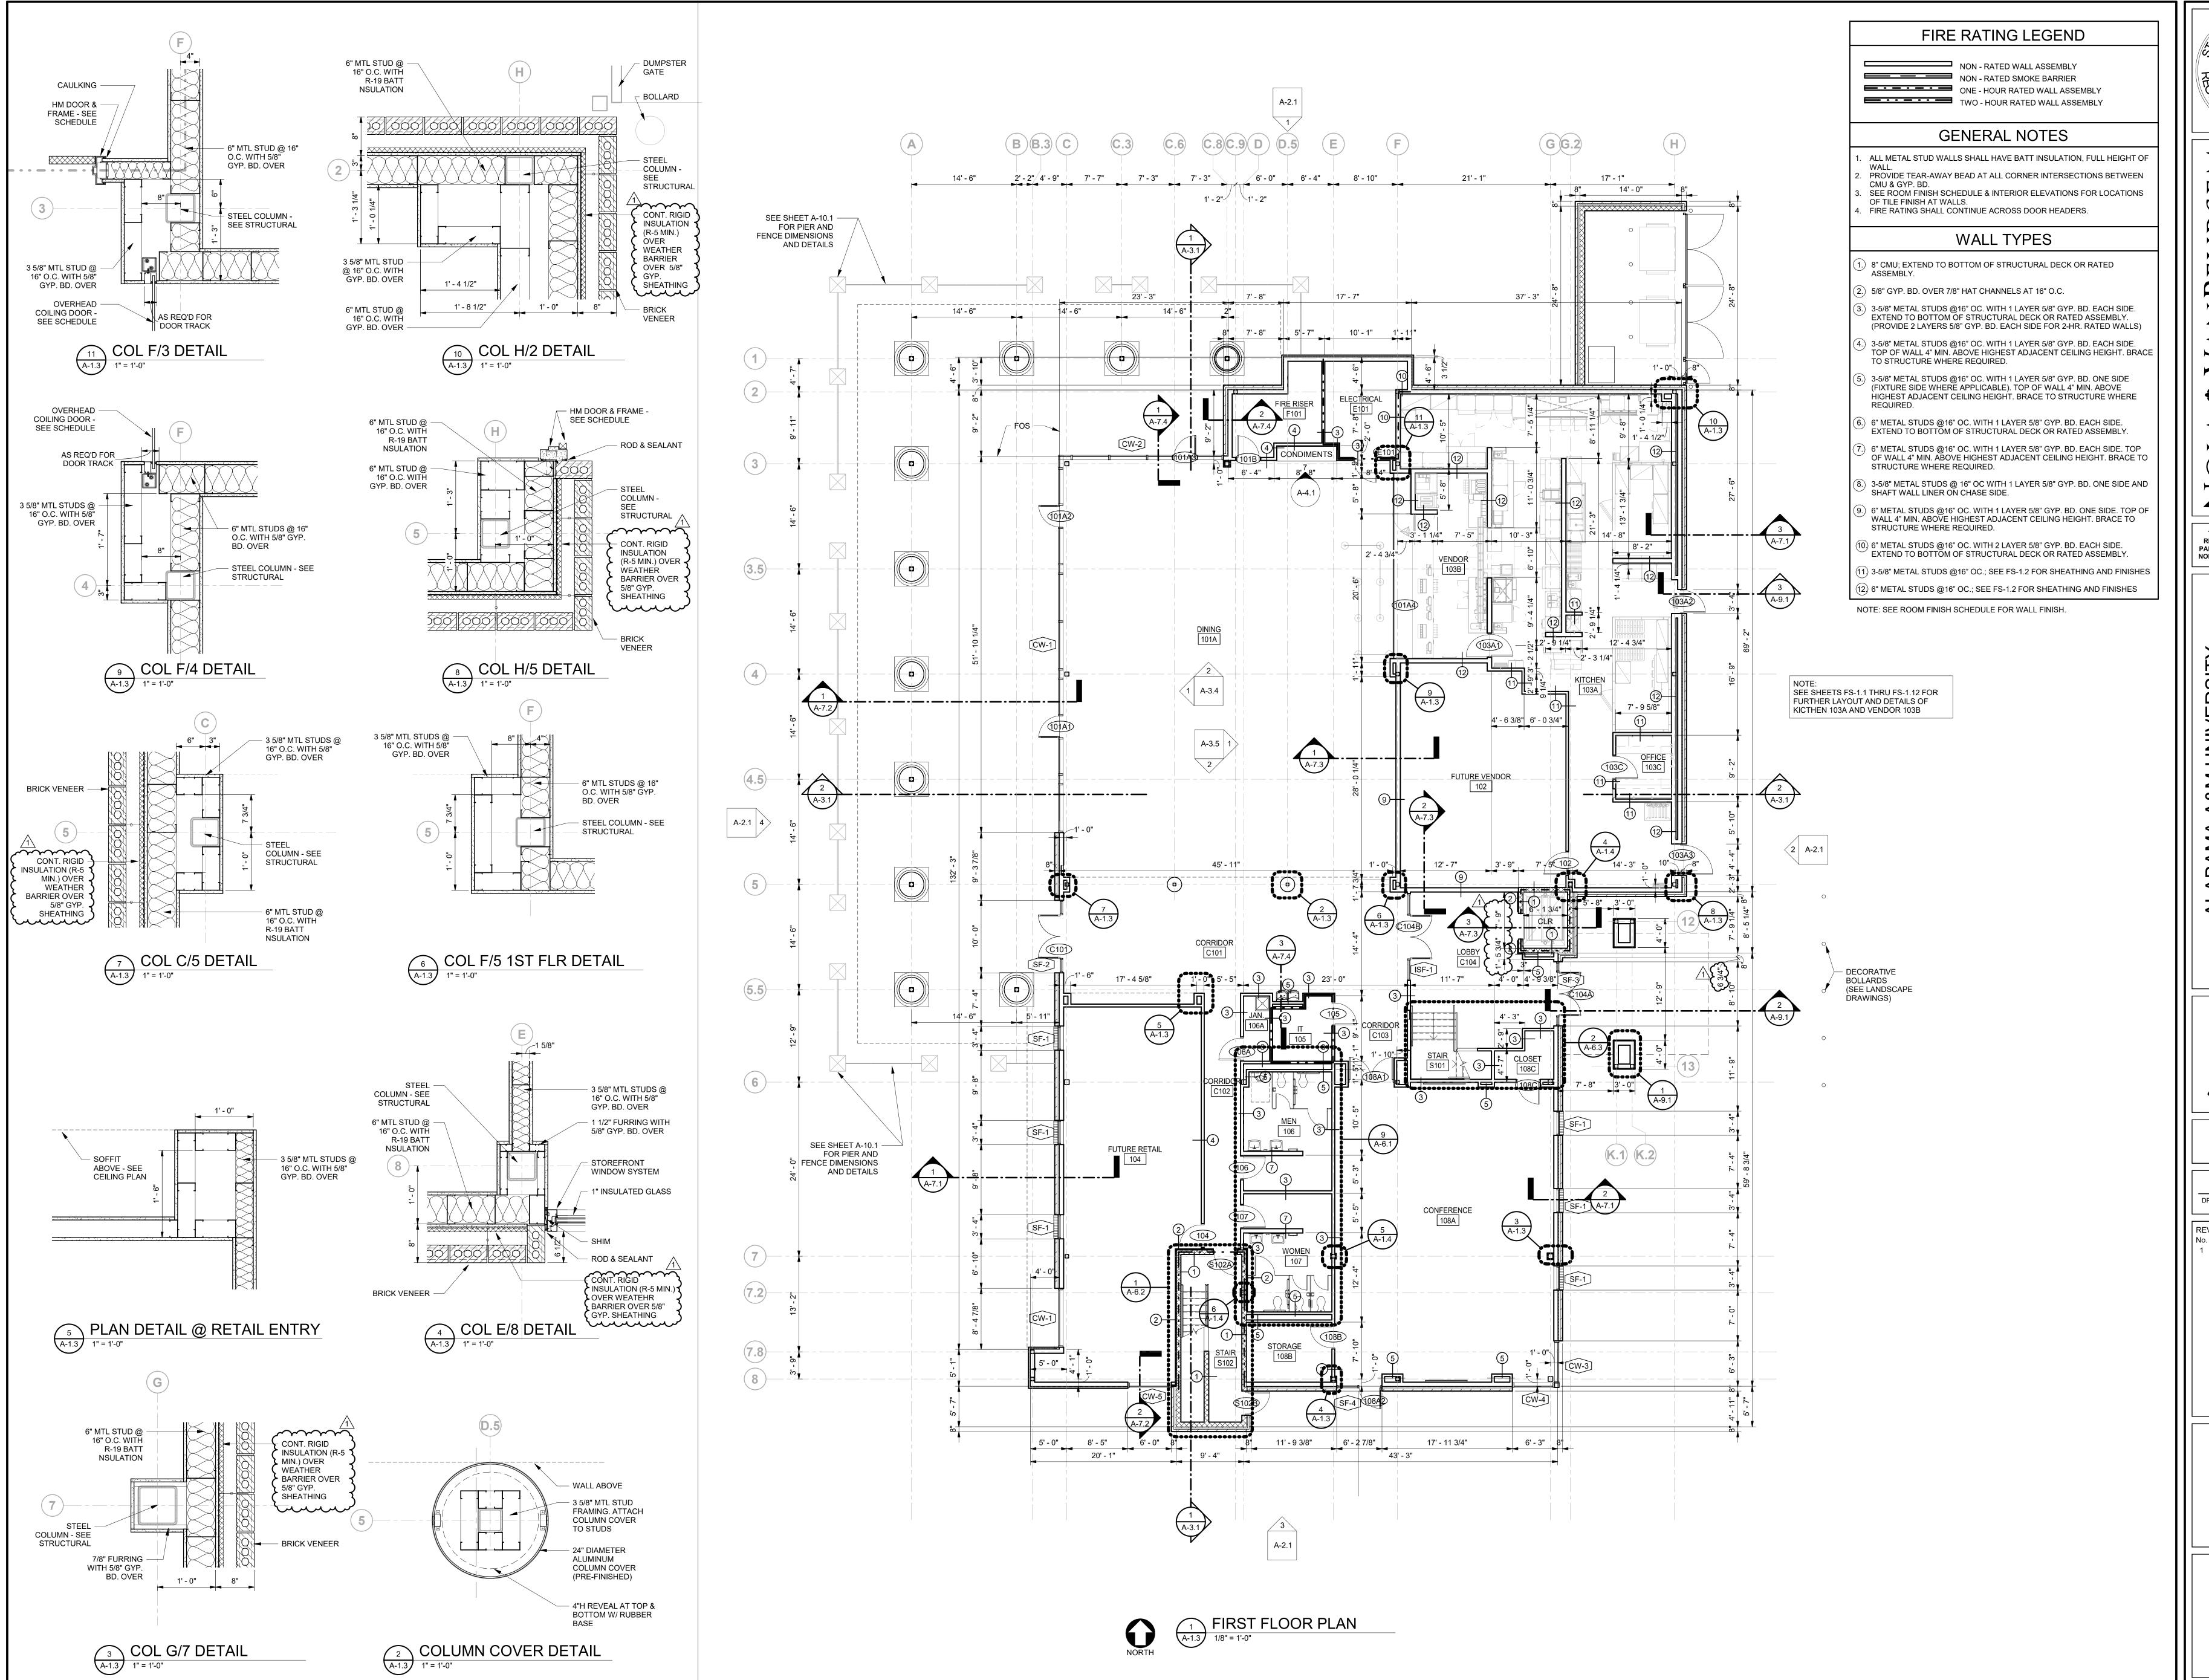
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Addendum #6 04-02-2021

CONSTRUCTION

C804

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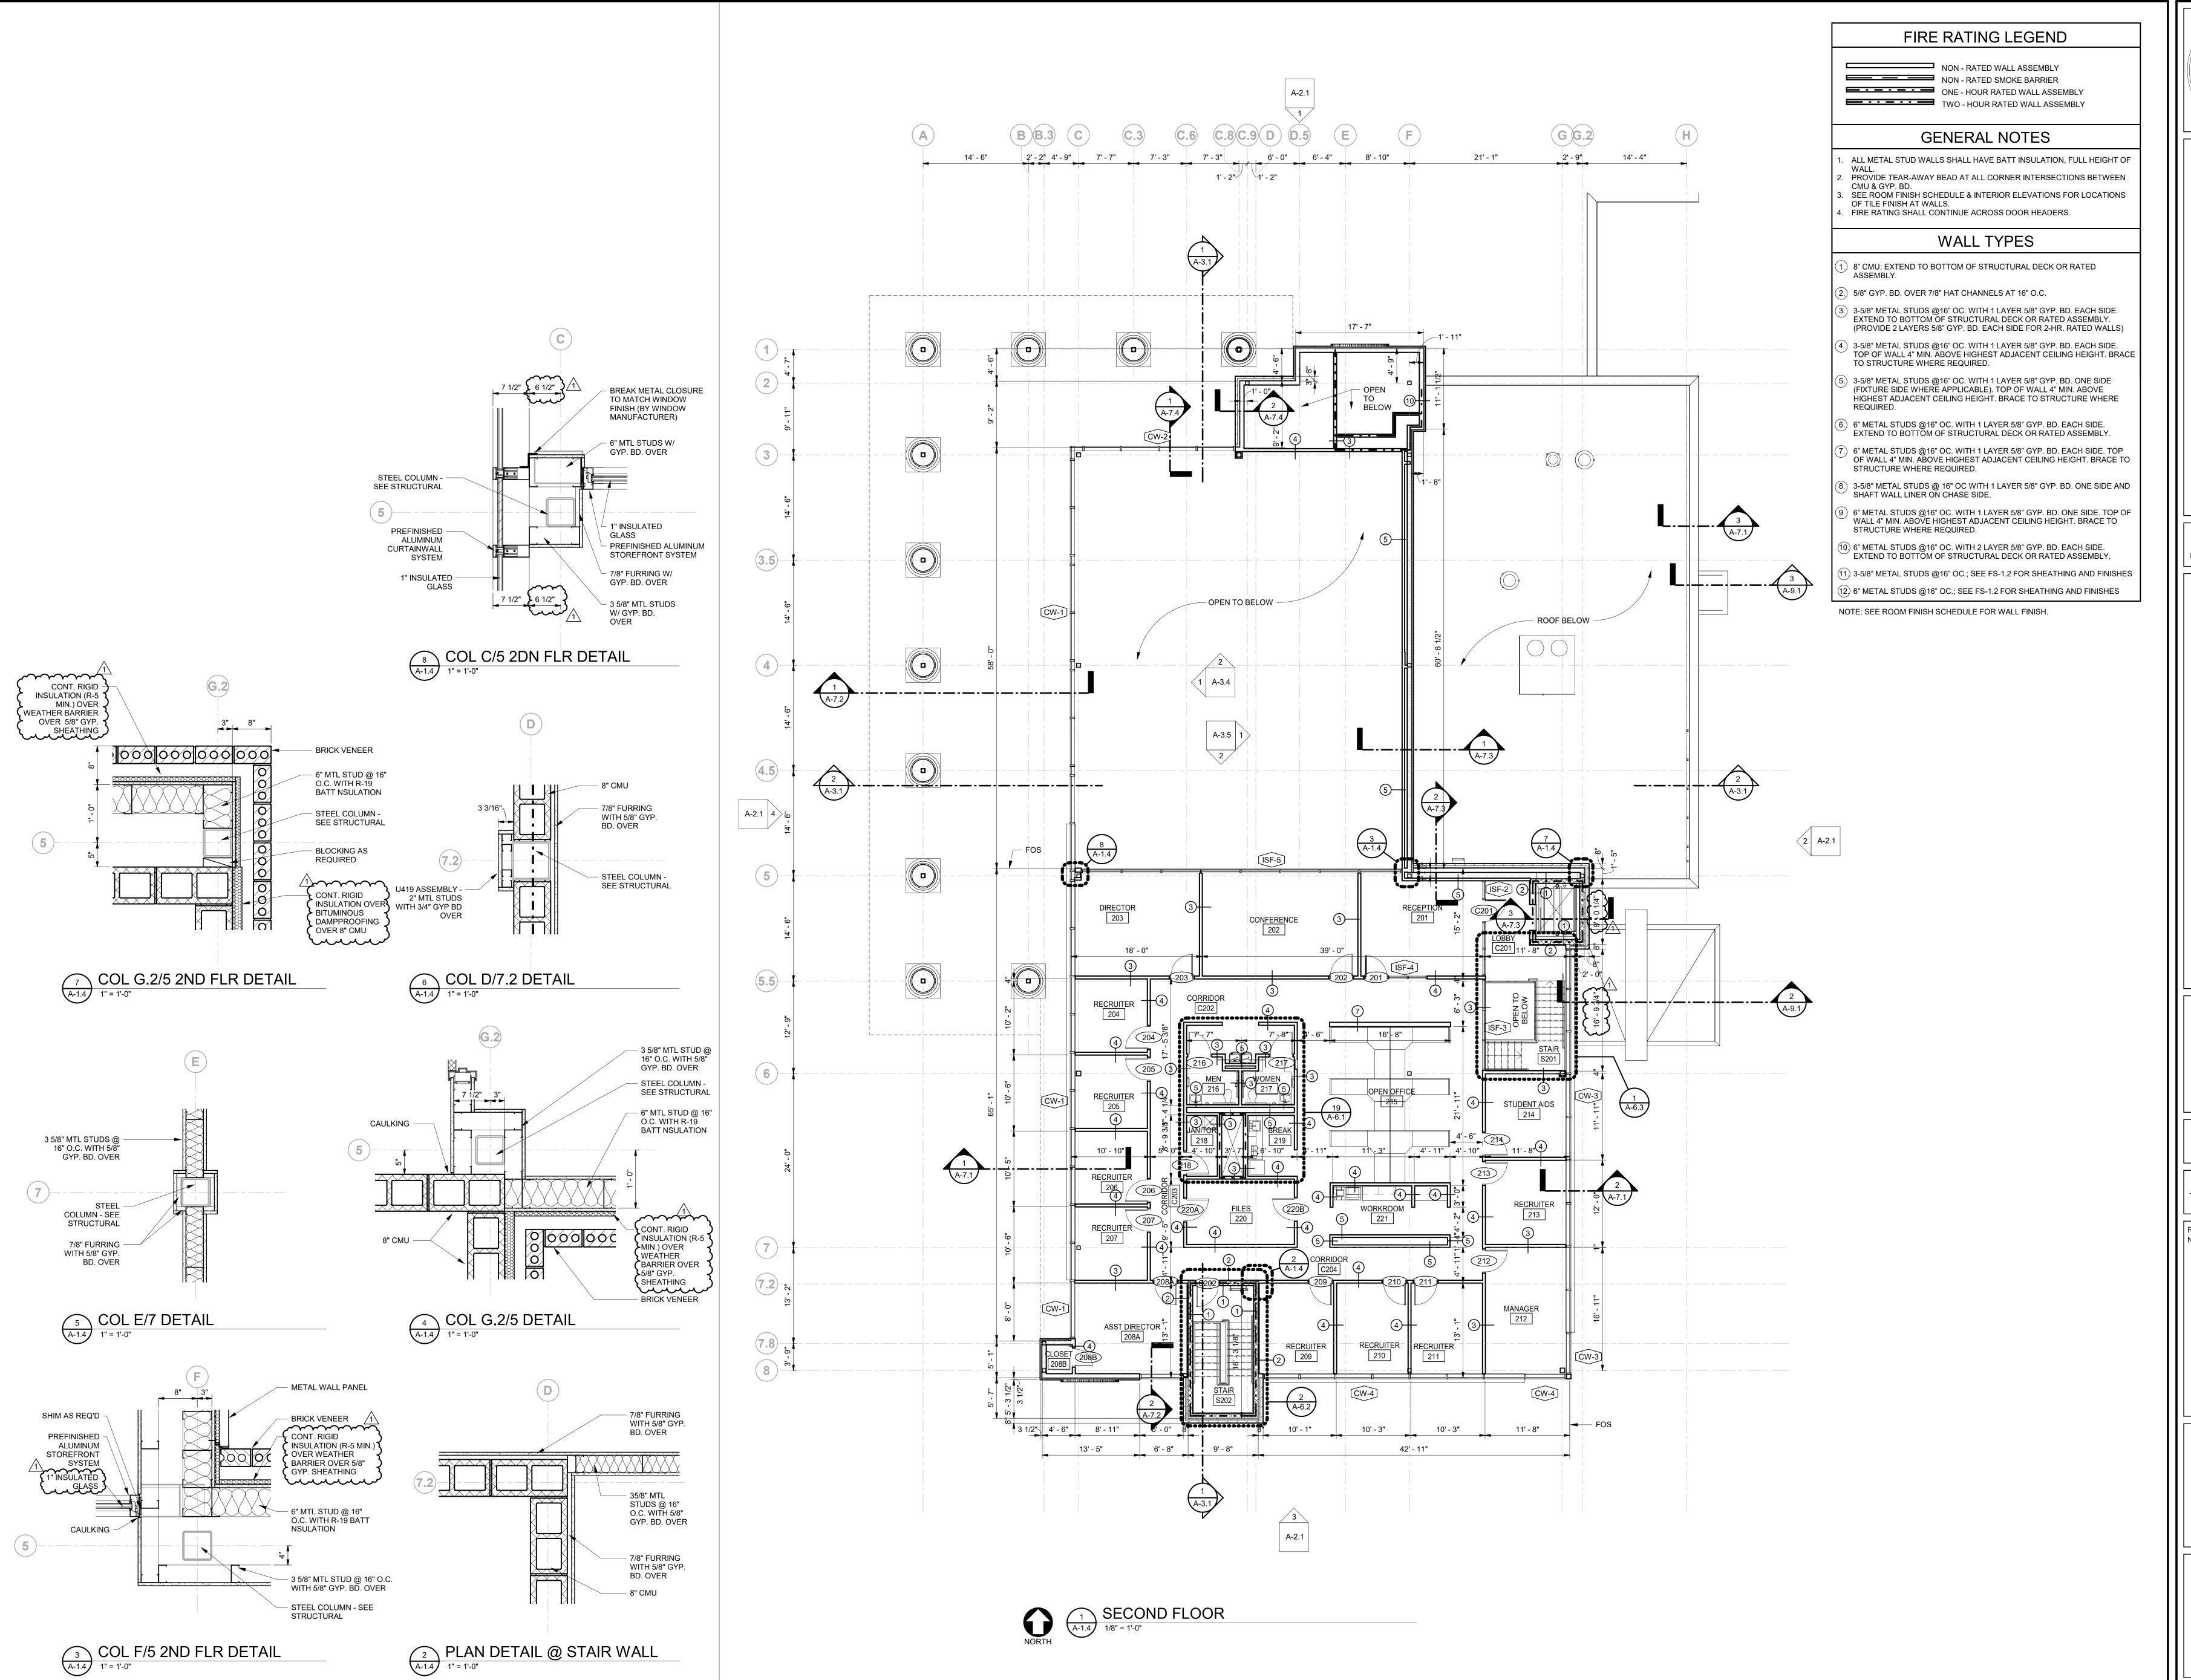
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Description ADDENDUM 6 4/1/2021

SHEET TITLE **FIRST FLOOR PLAN**

SHEET NUMBER A-1.3



JOB NUMBER


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Description ADDENDUM 6 4/1/2021

SHEET TITLE **SECOND FLOOR**

SHEET NUMBER

A-1.4

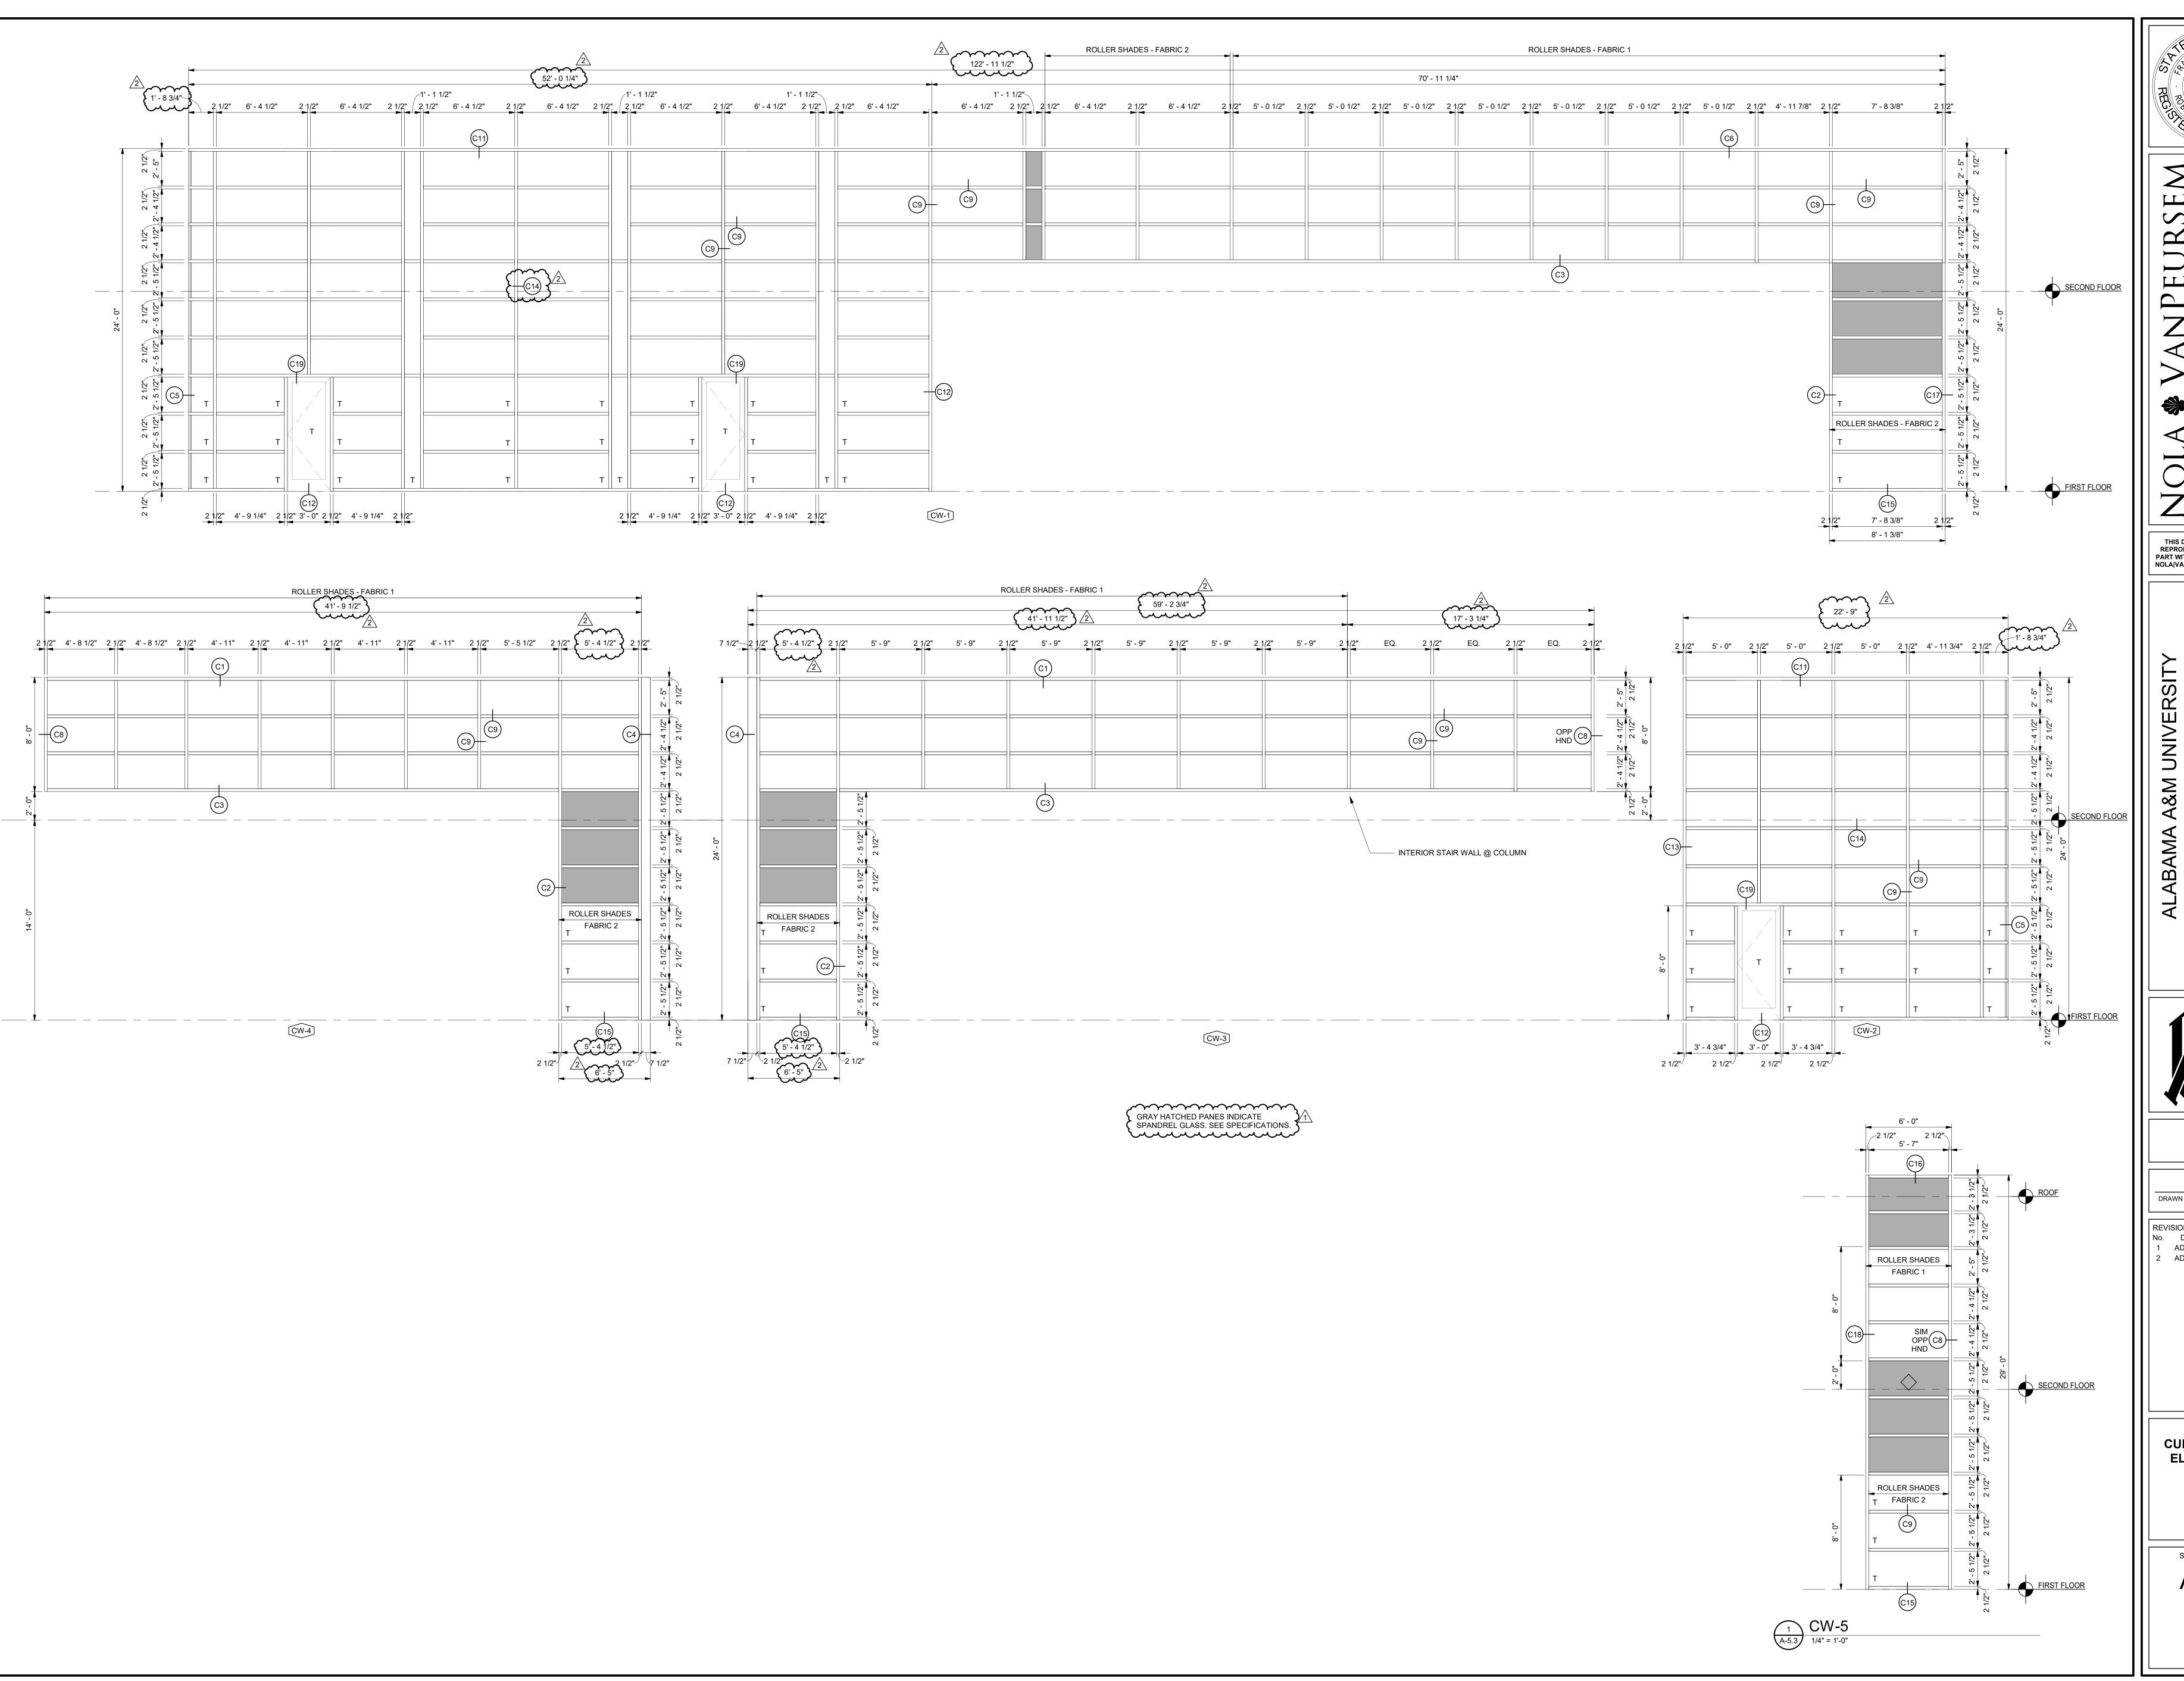

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ARCHITECTS, PC

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ADDENDUM 6 4/1/2021


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CURTAINWALL

ELEVATIONS

SHEET NUMBER

A-5.3



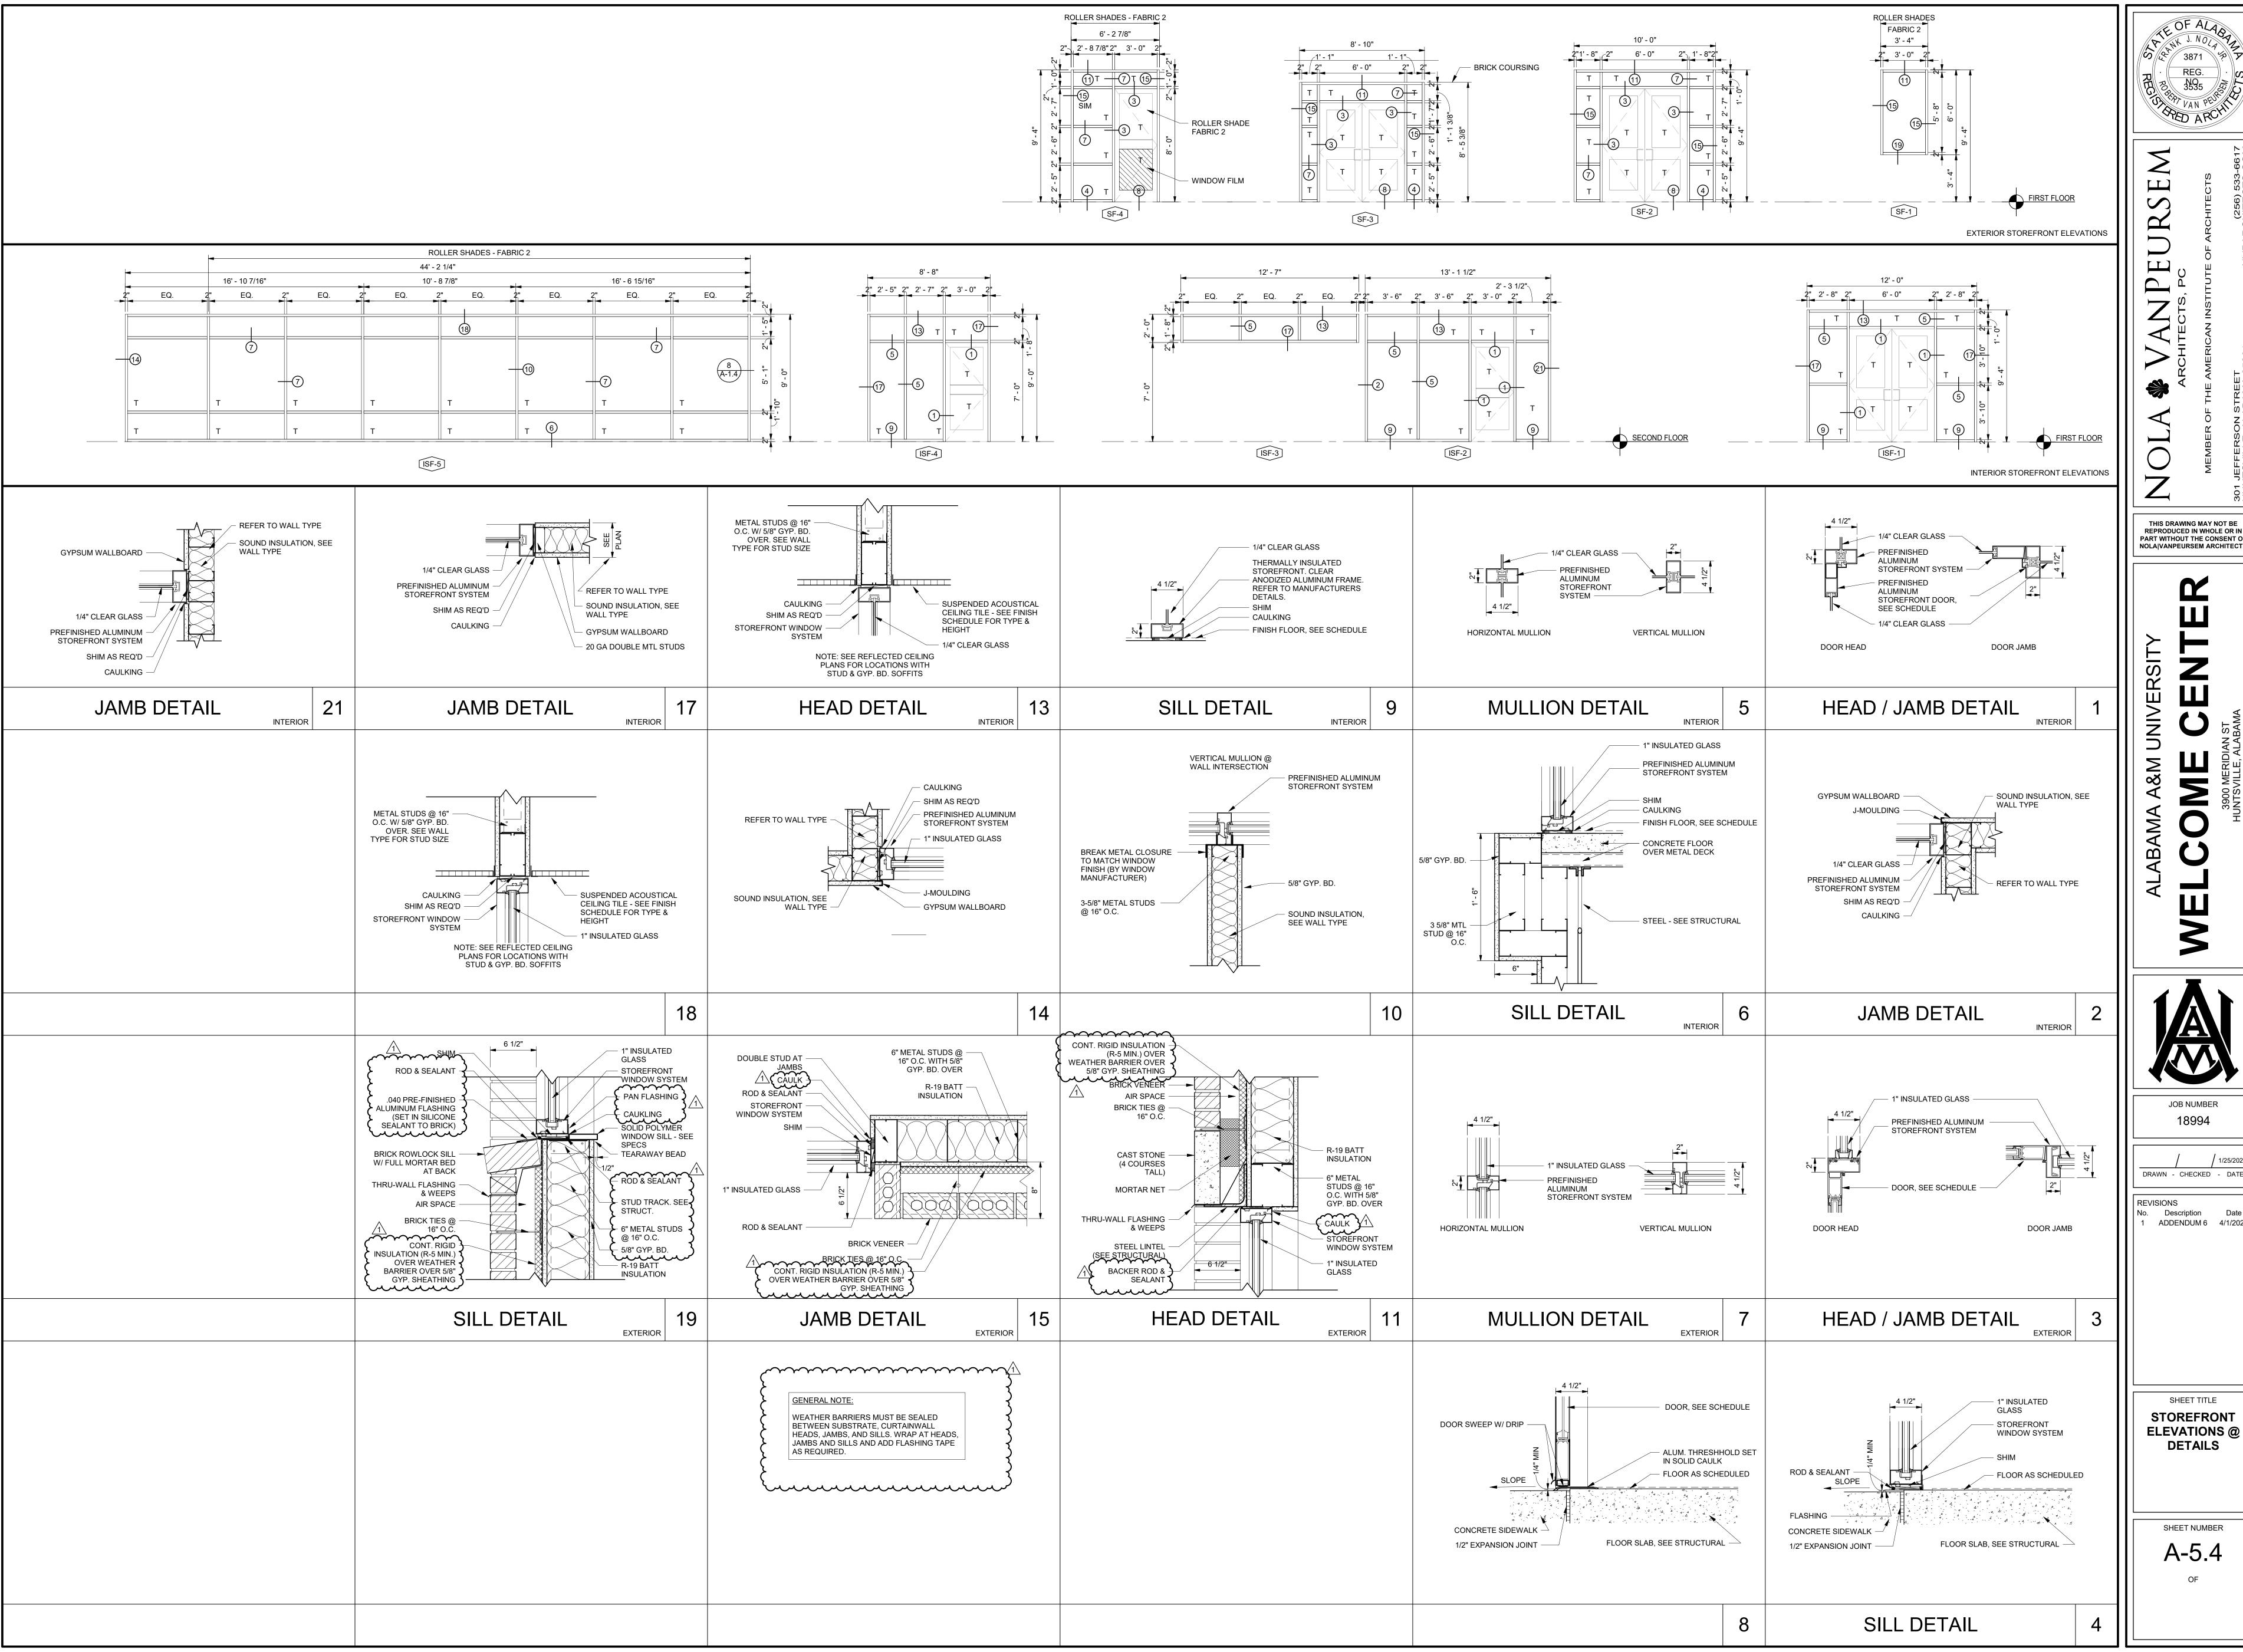

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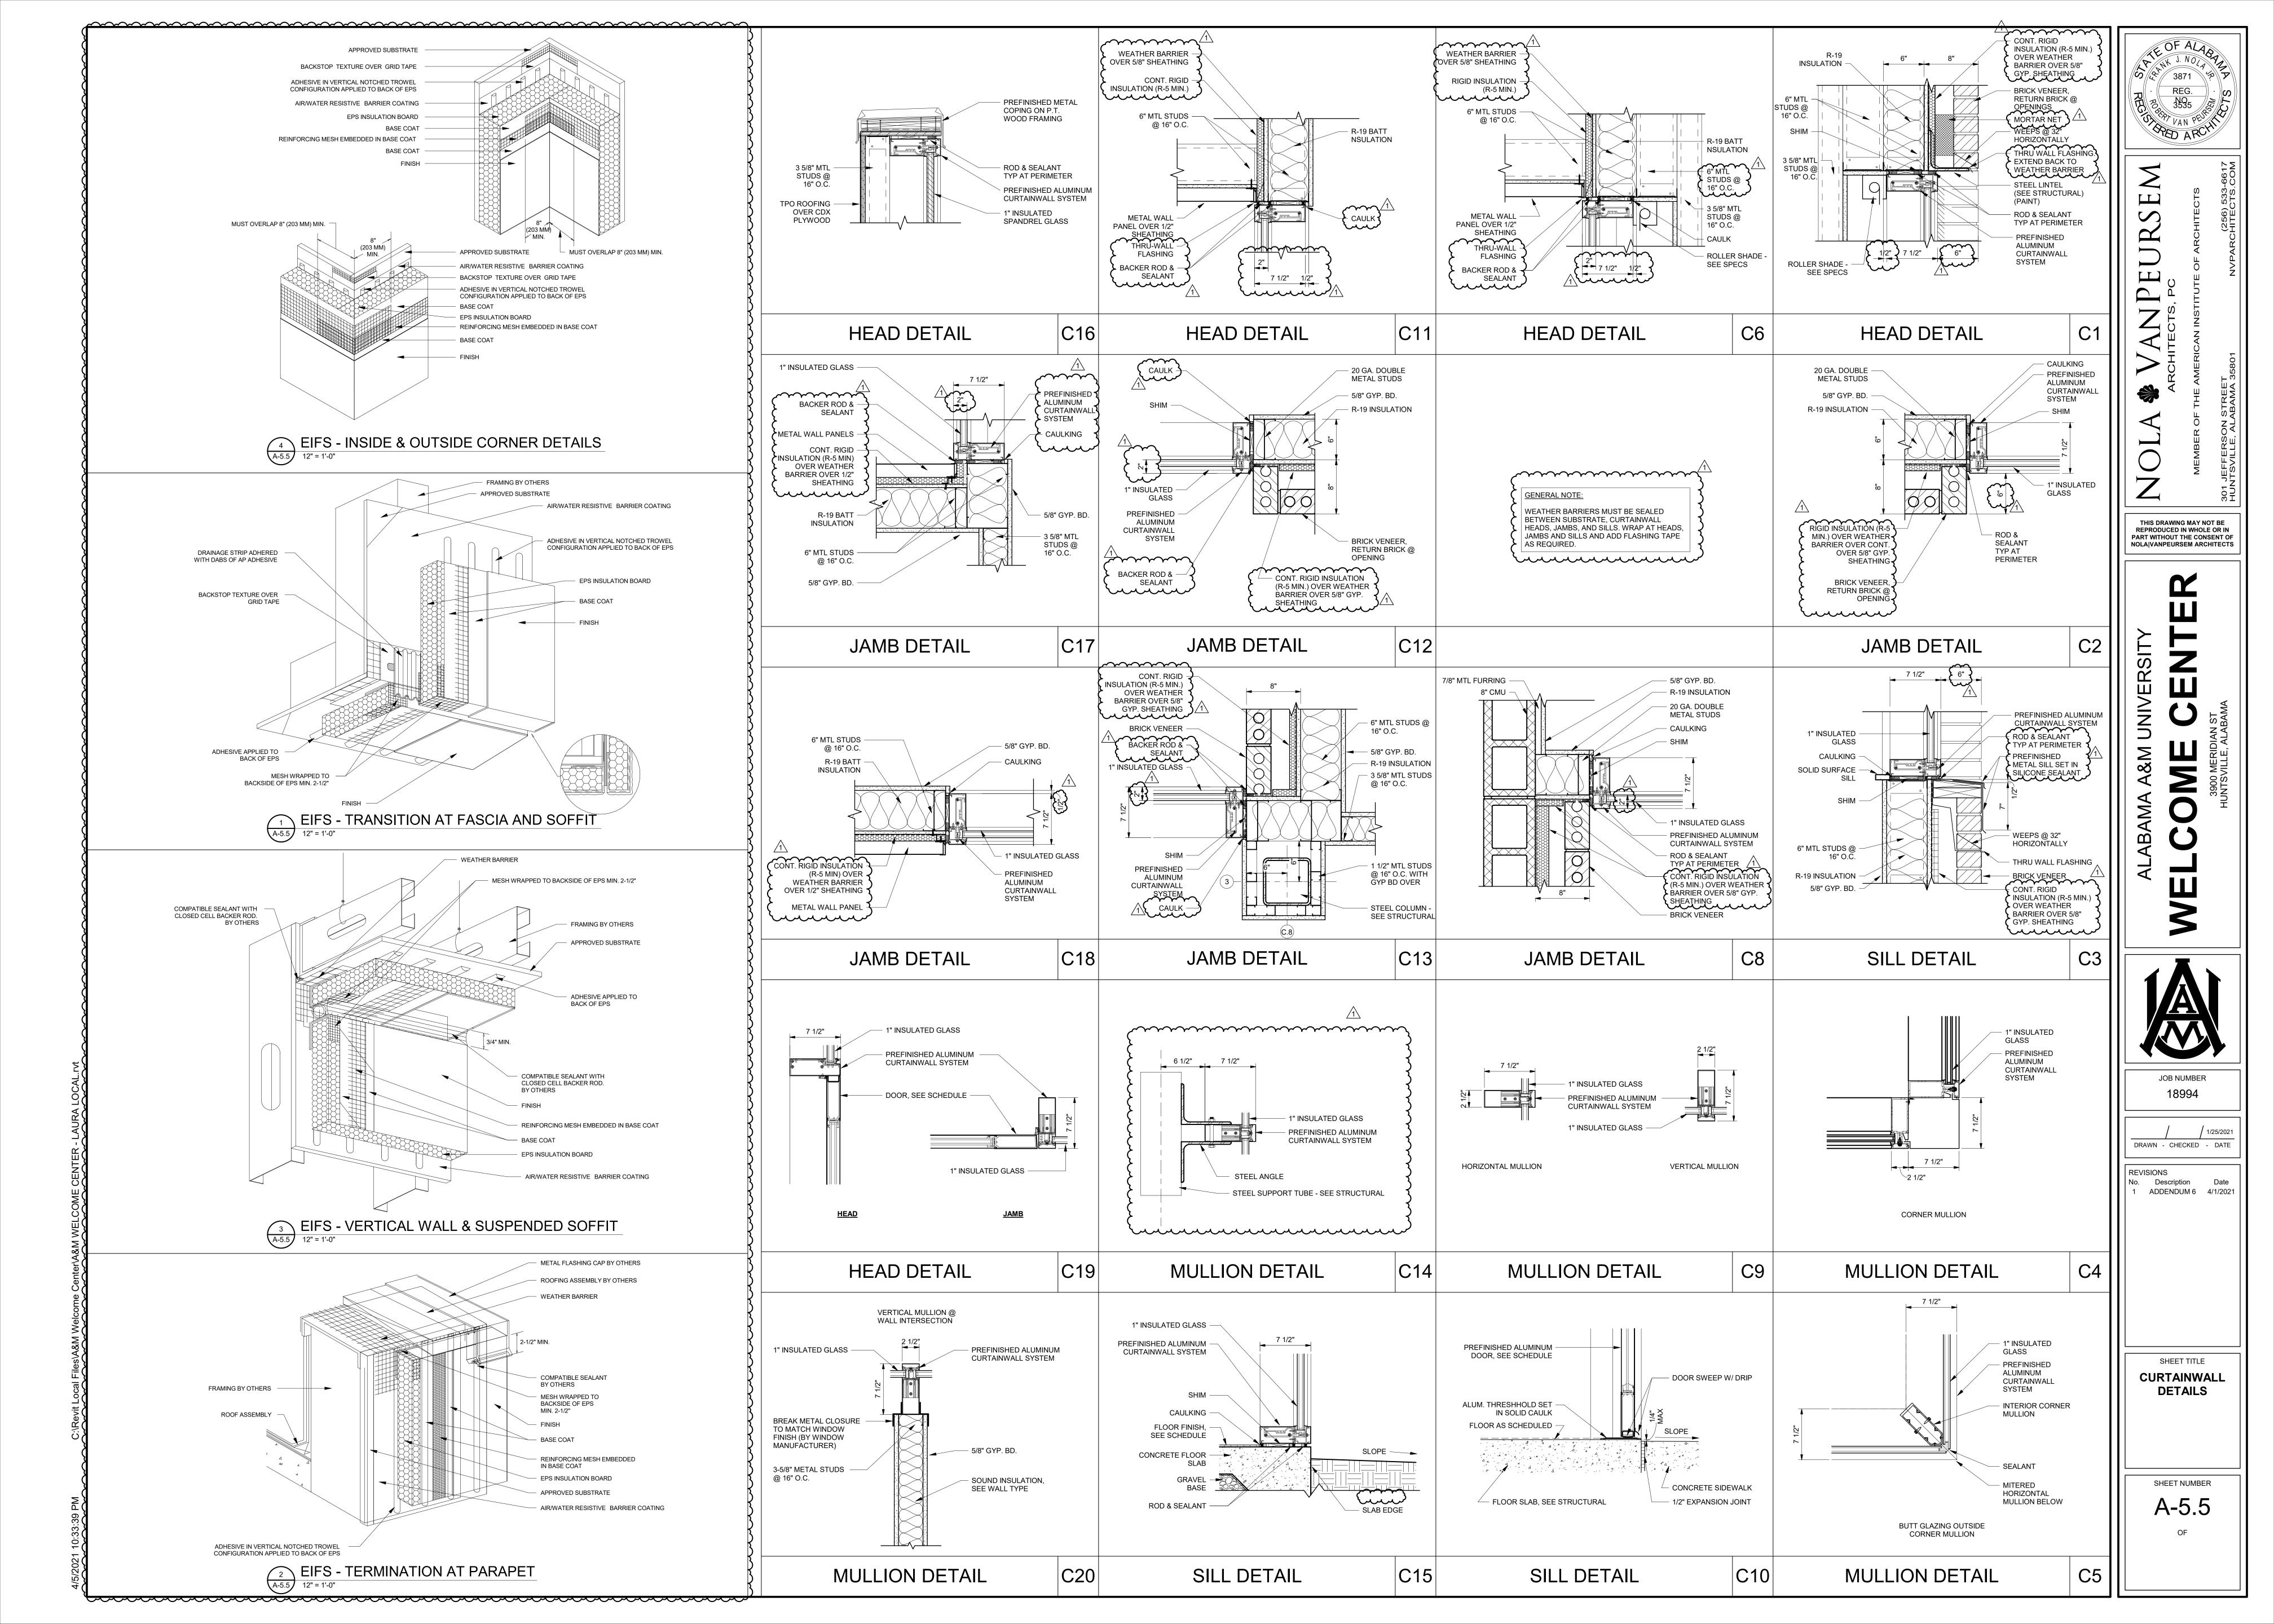
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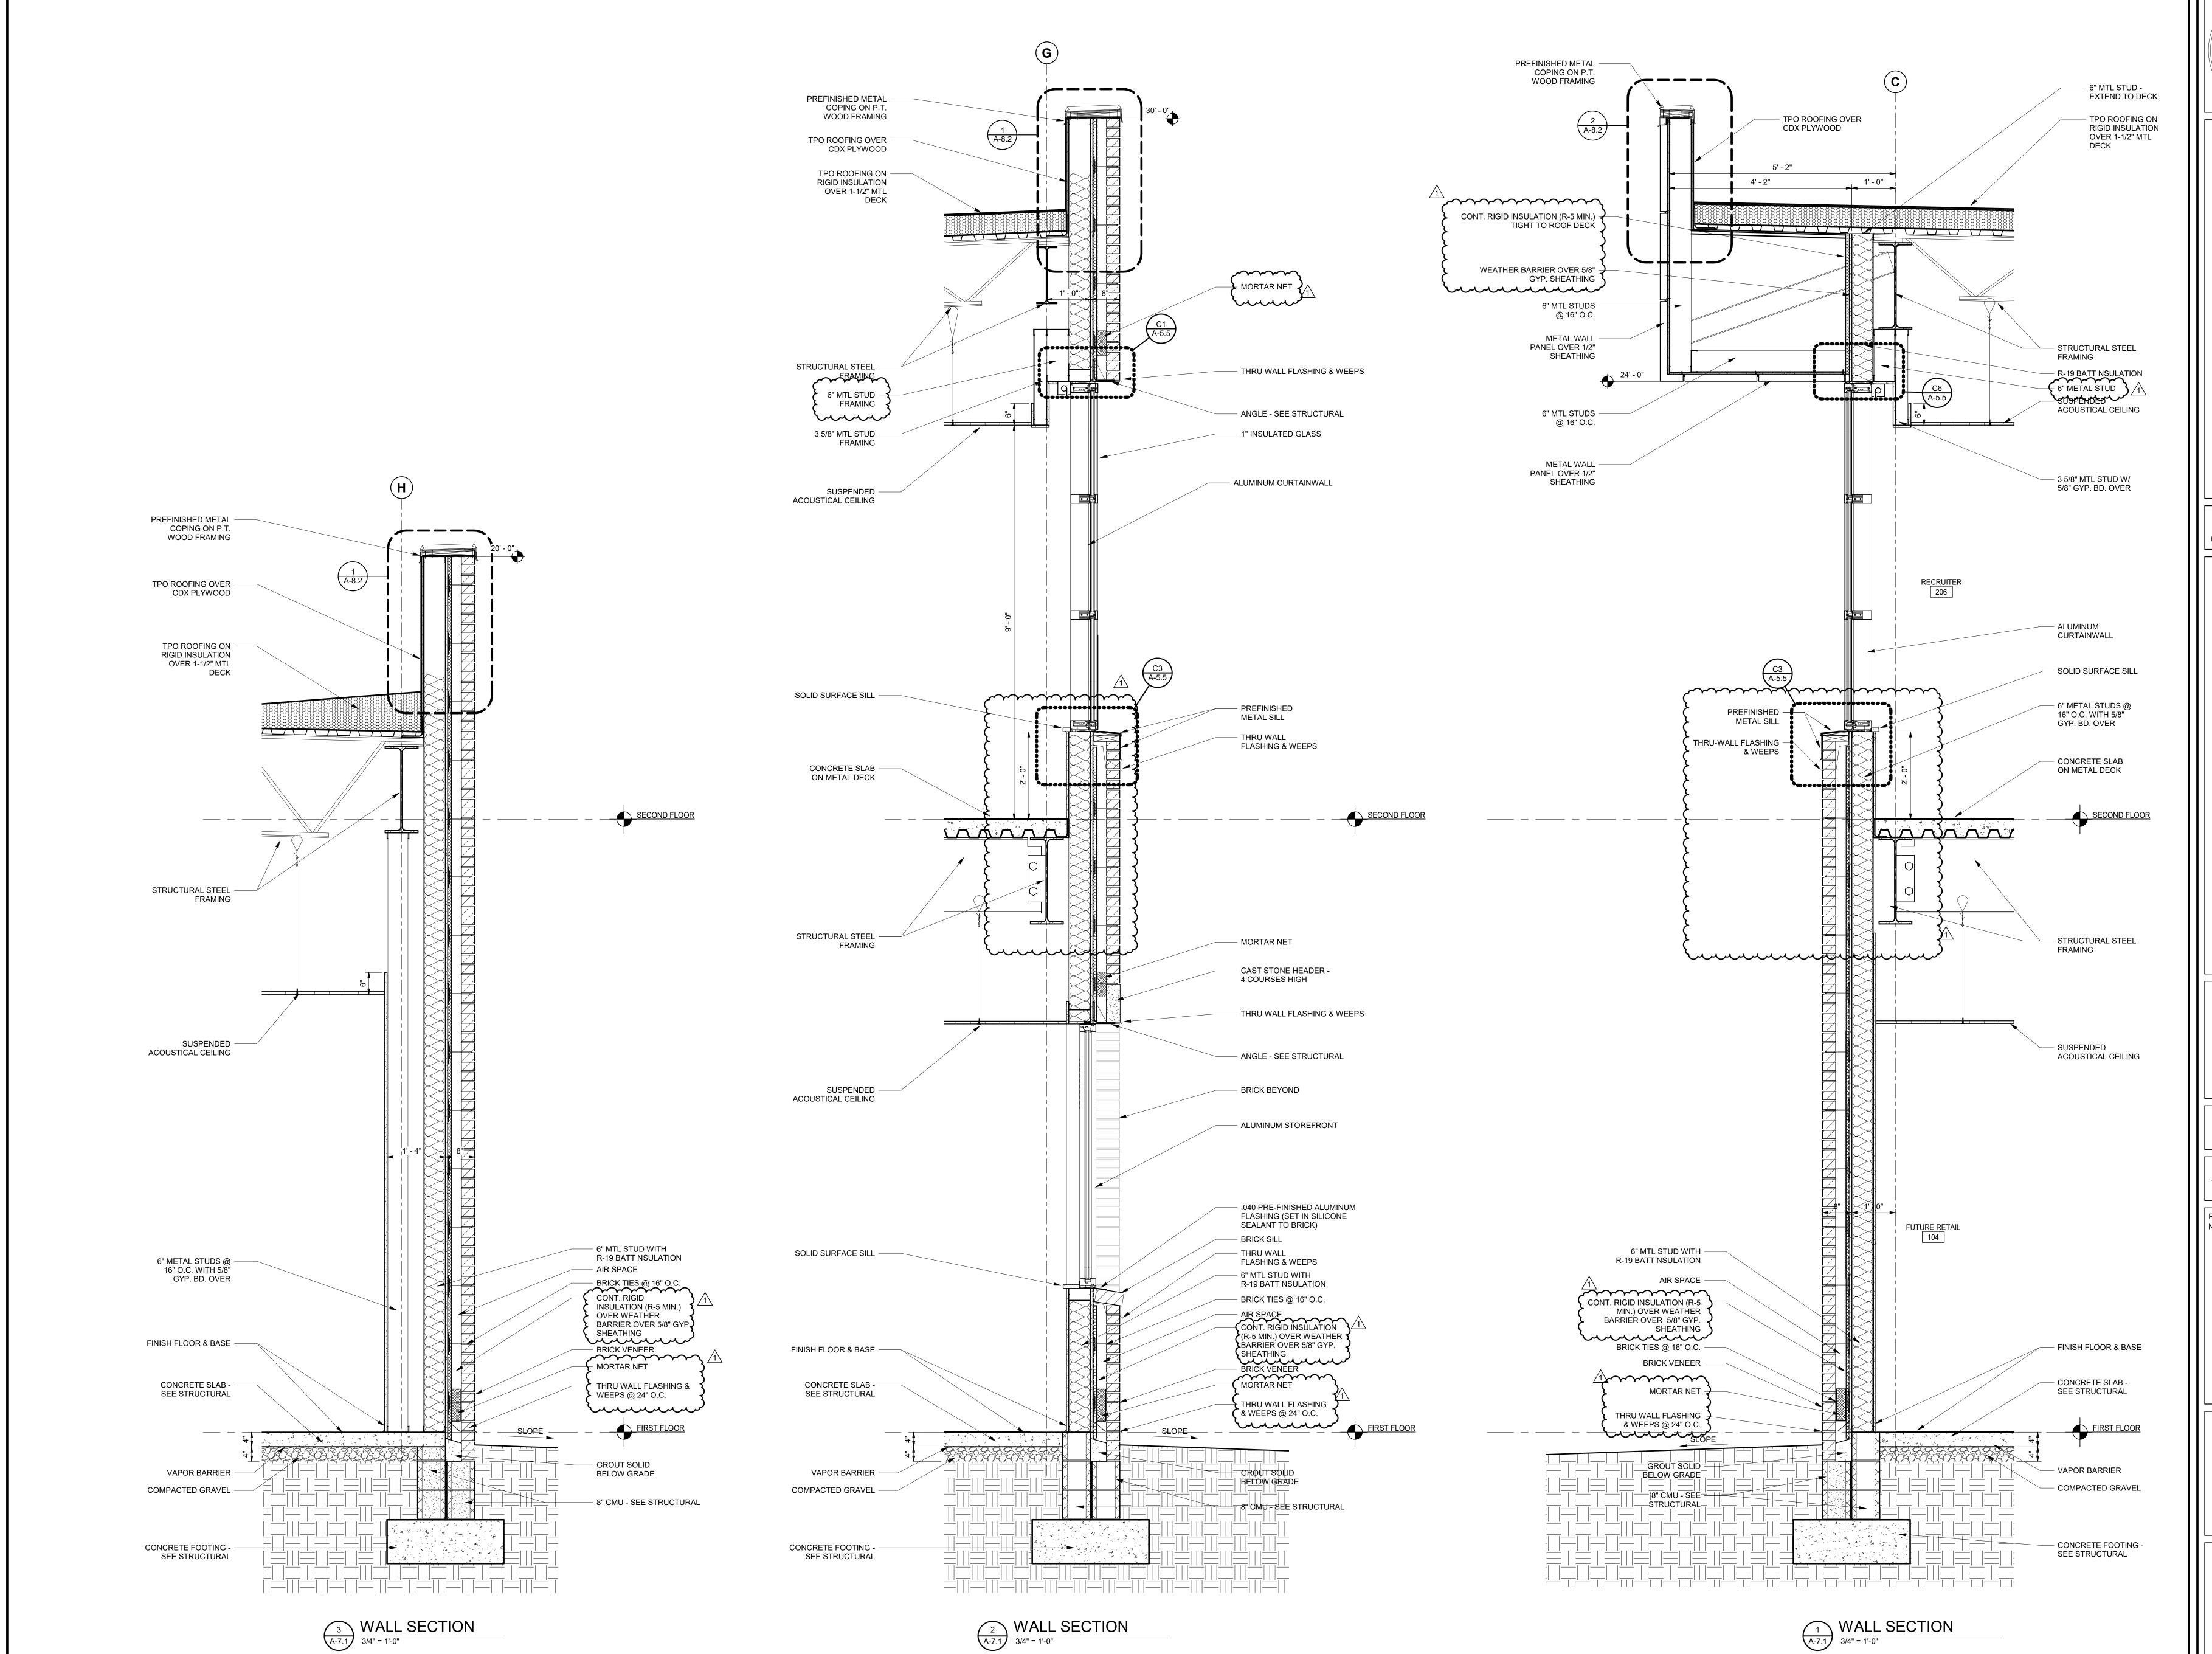
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ADDENDUM 6 4/1/2021

SHEET TITLE **STOREFRONT ELEVATIONS** @

SHEET NUMBER







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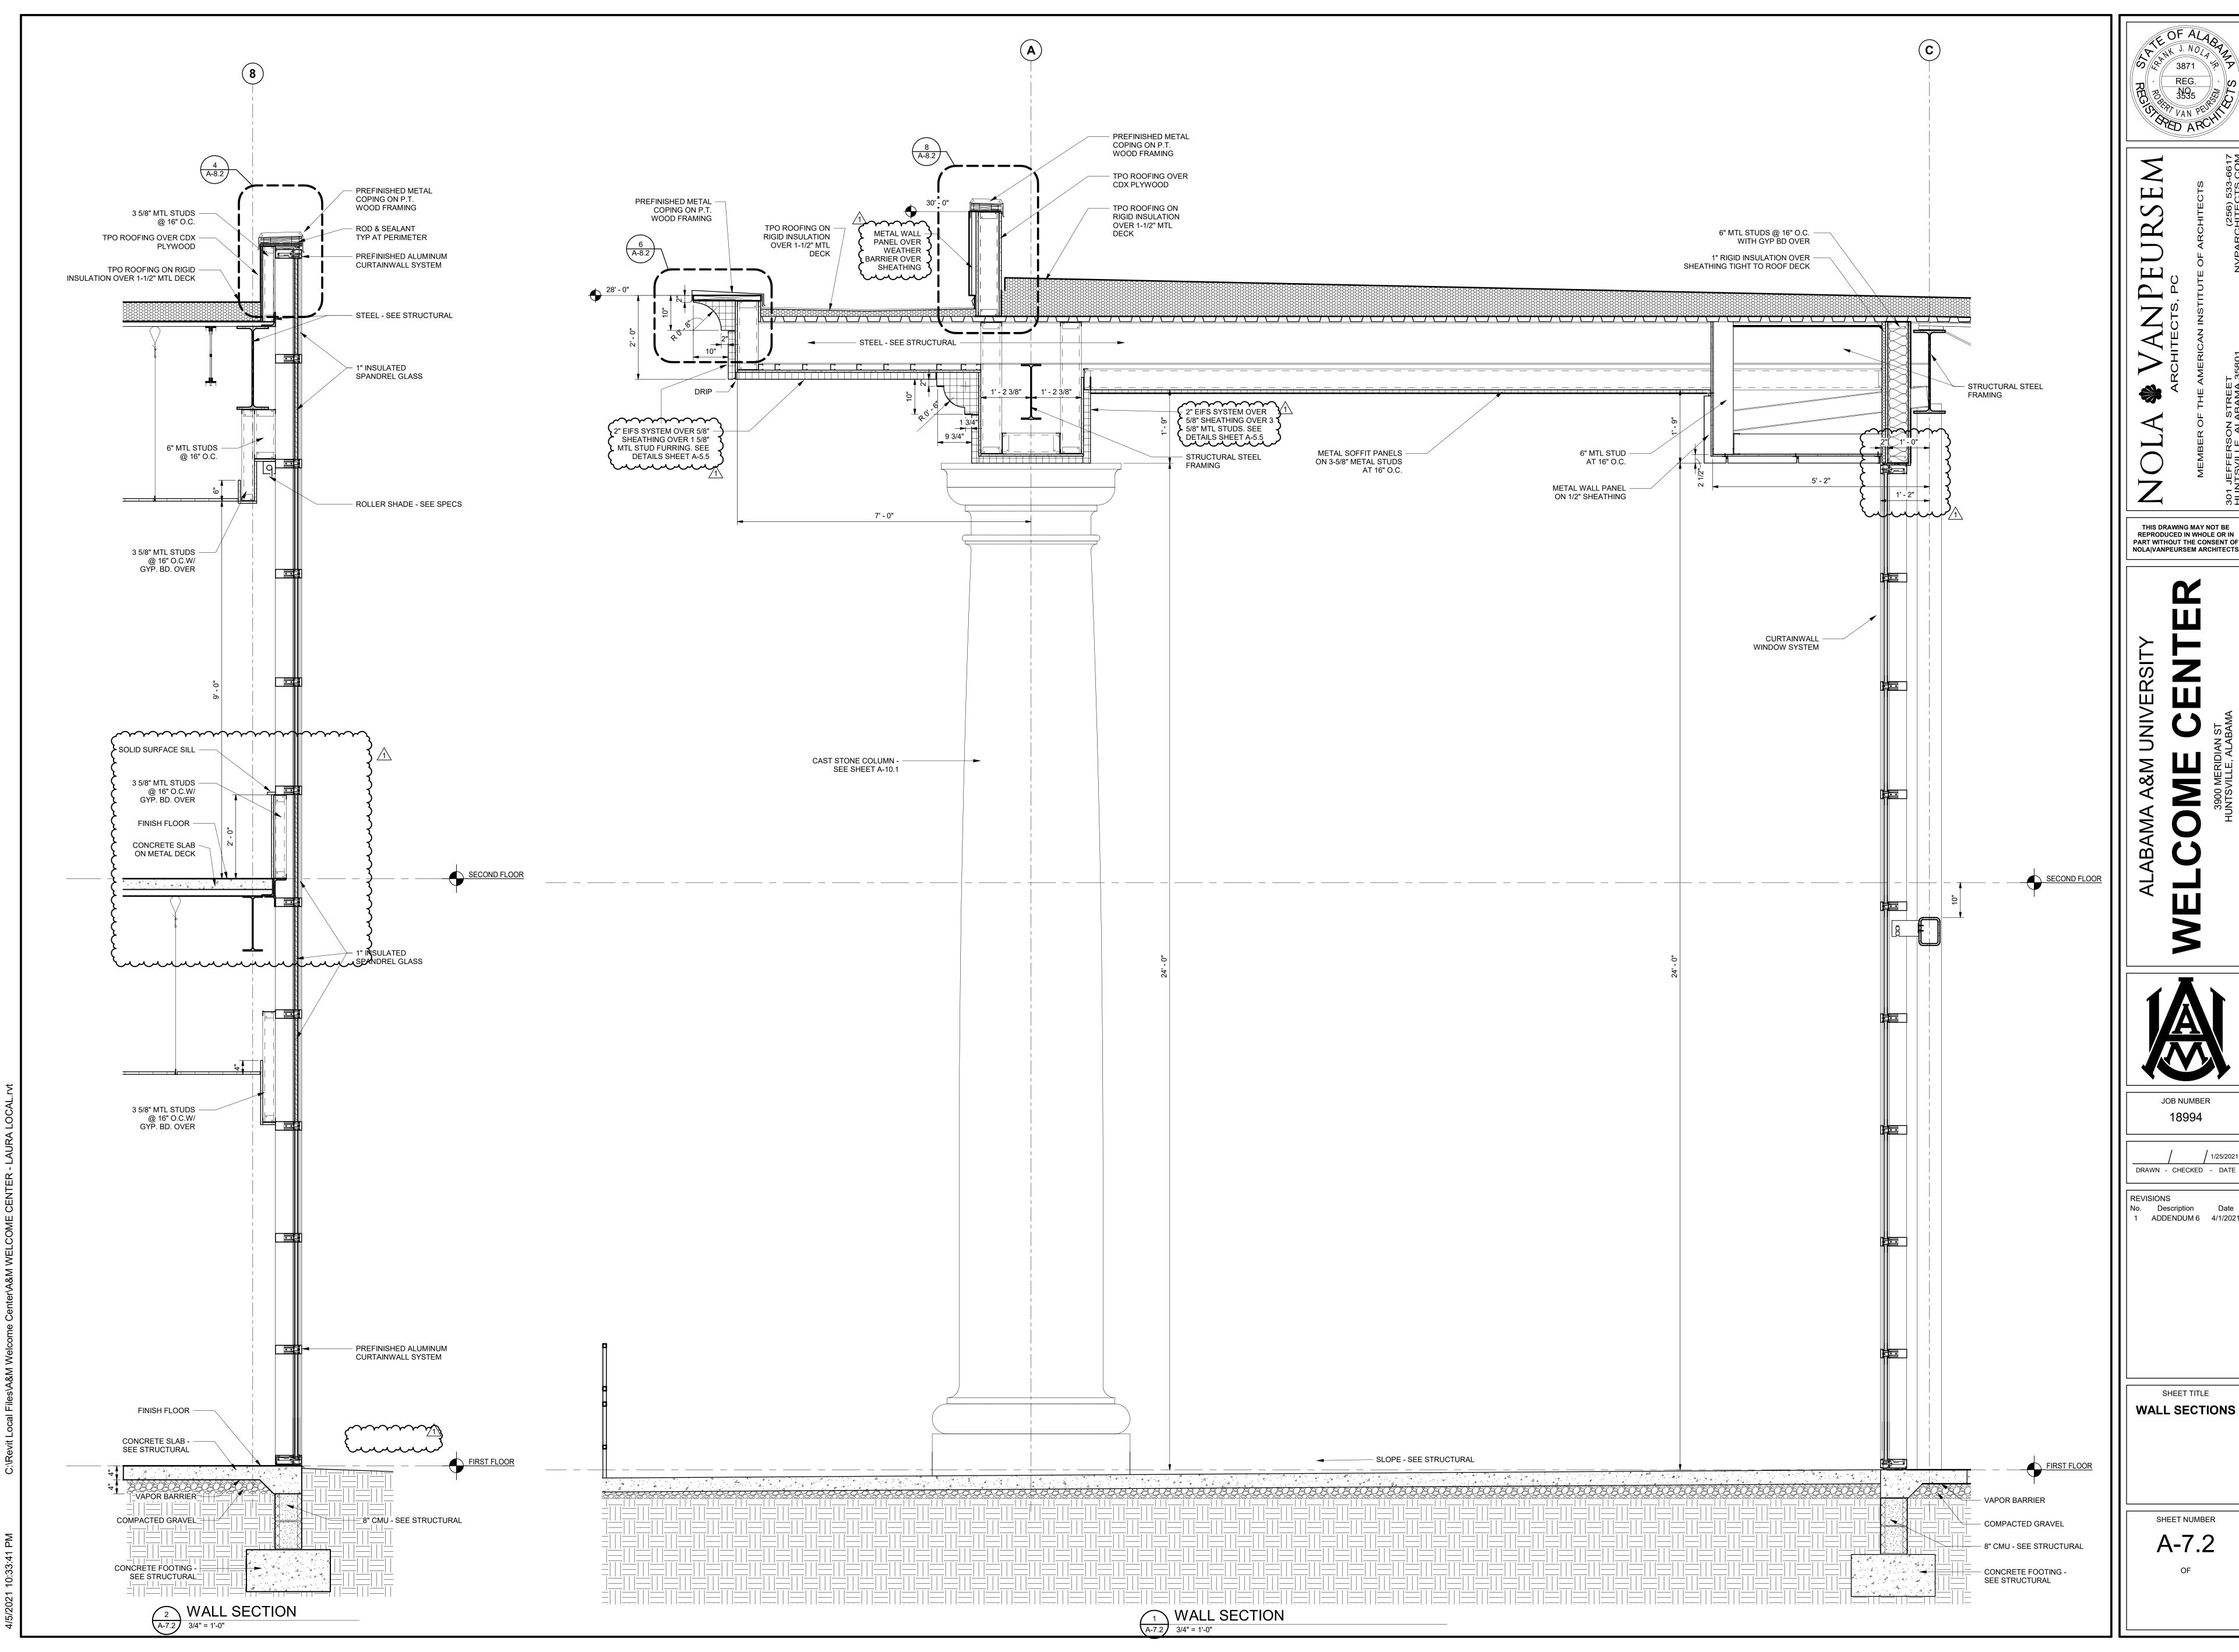
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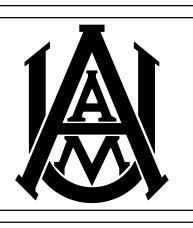
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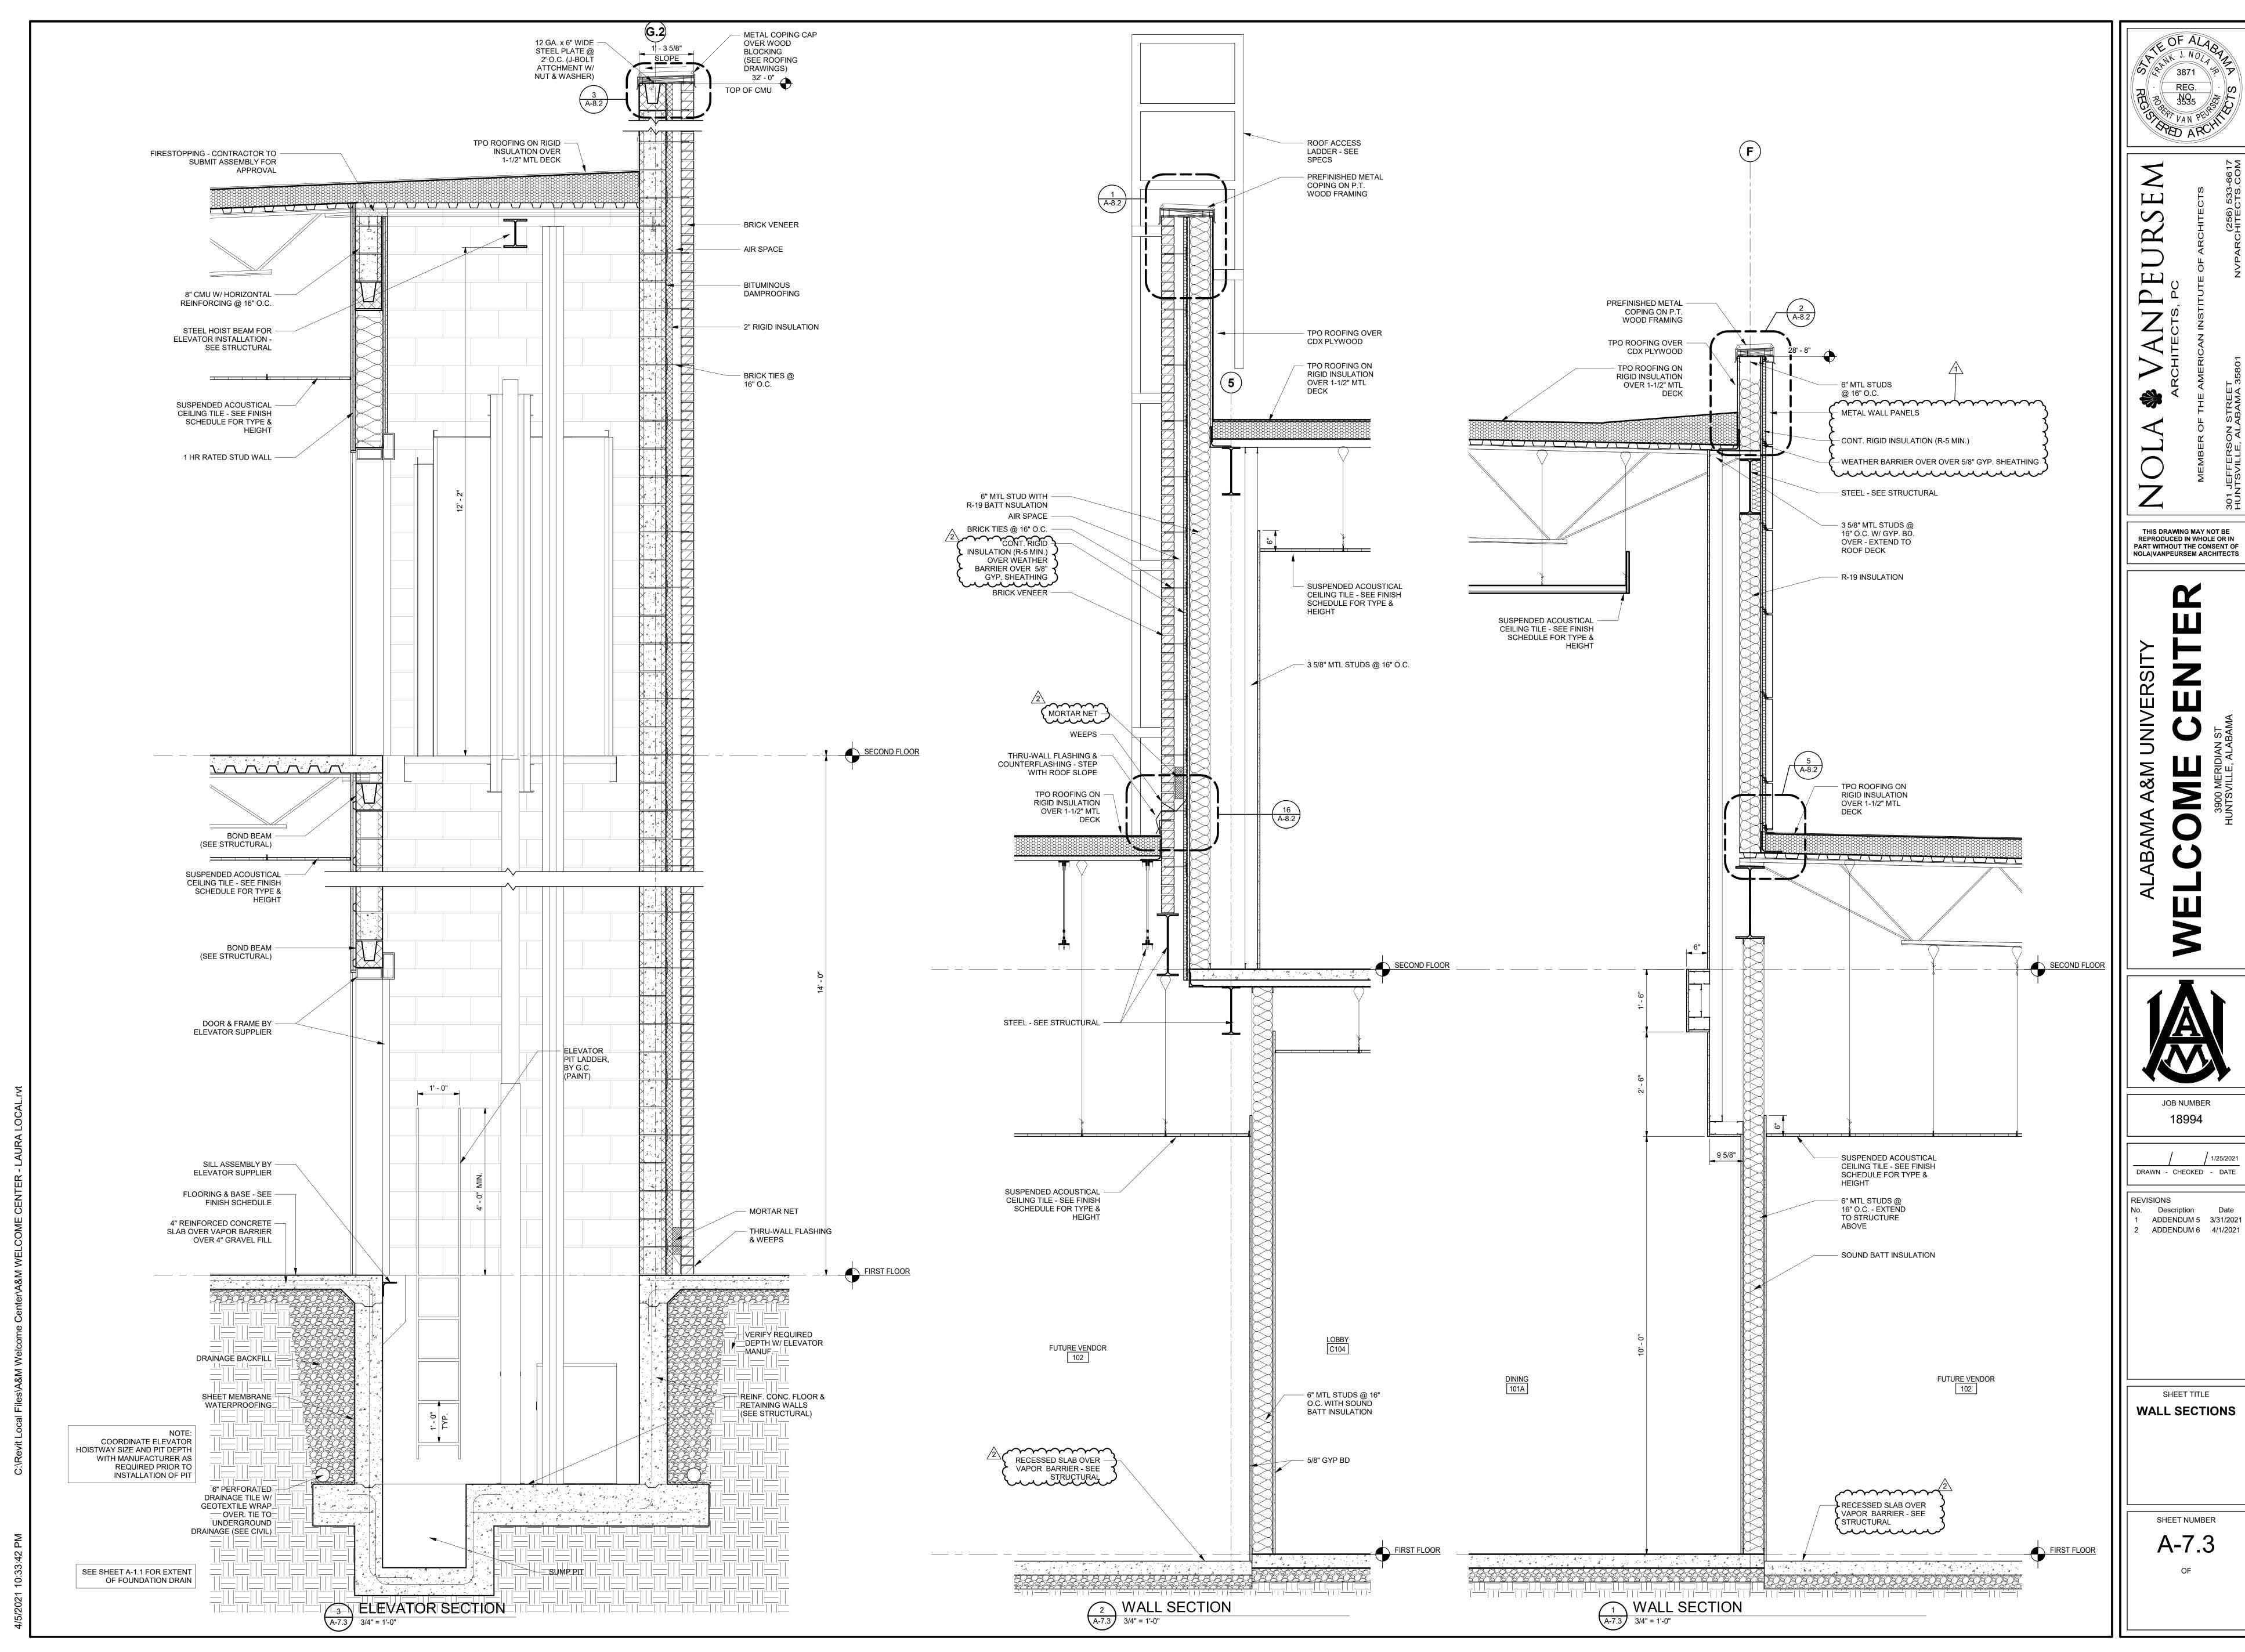
WALL SECTIONS

SHEET NUMBER A-7.1 OF





Description Date
ADDENDUM 6 4/1/2021





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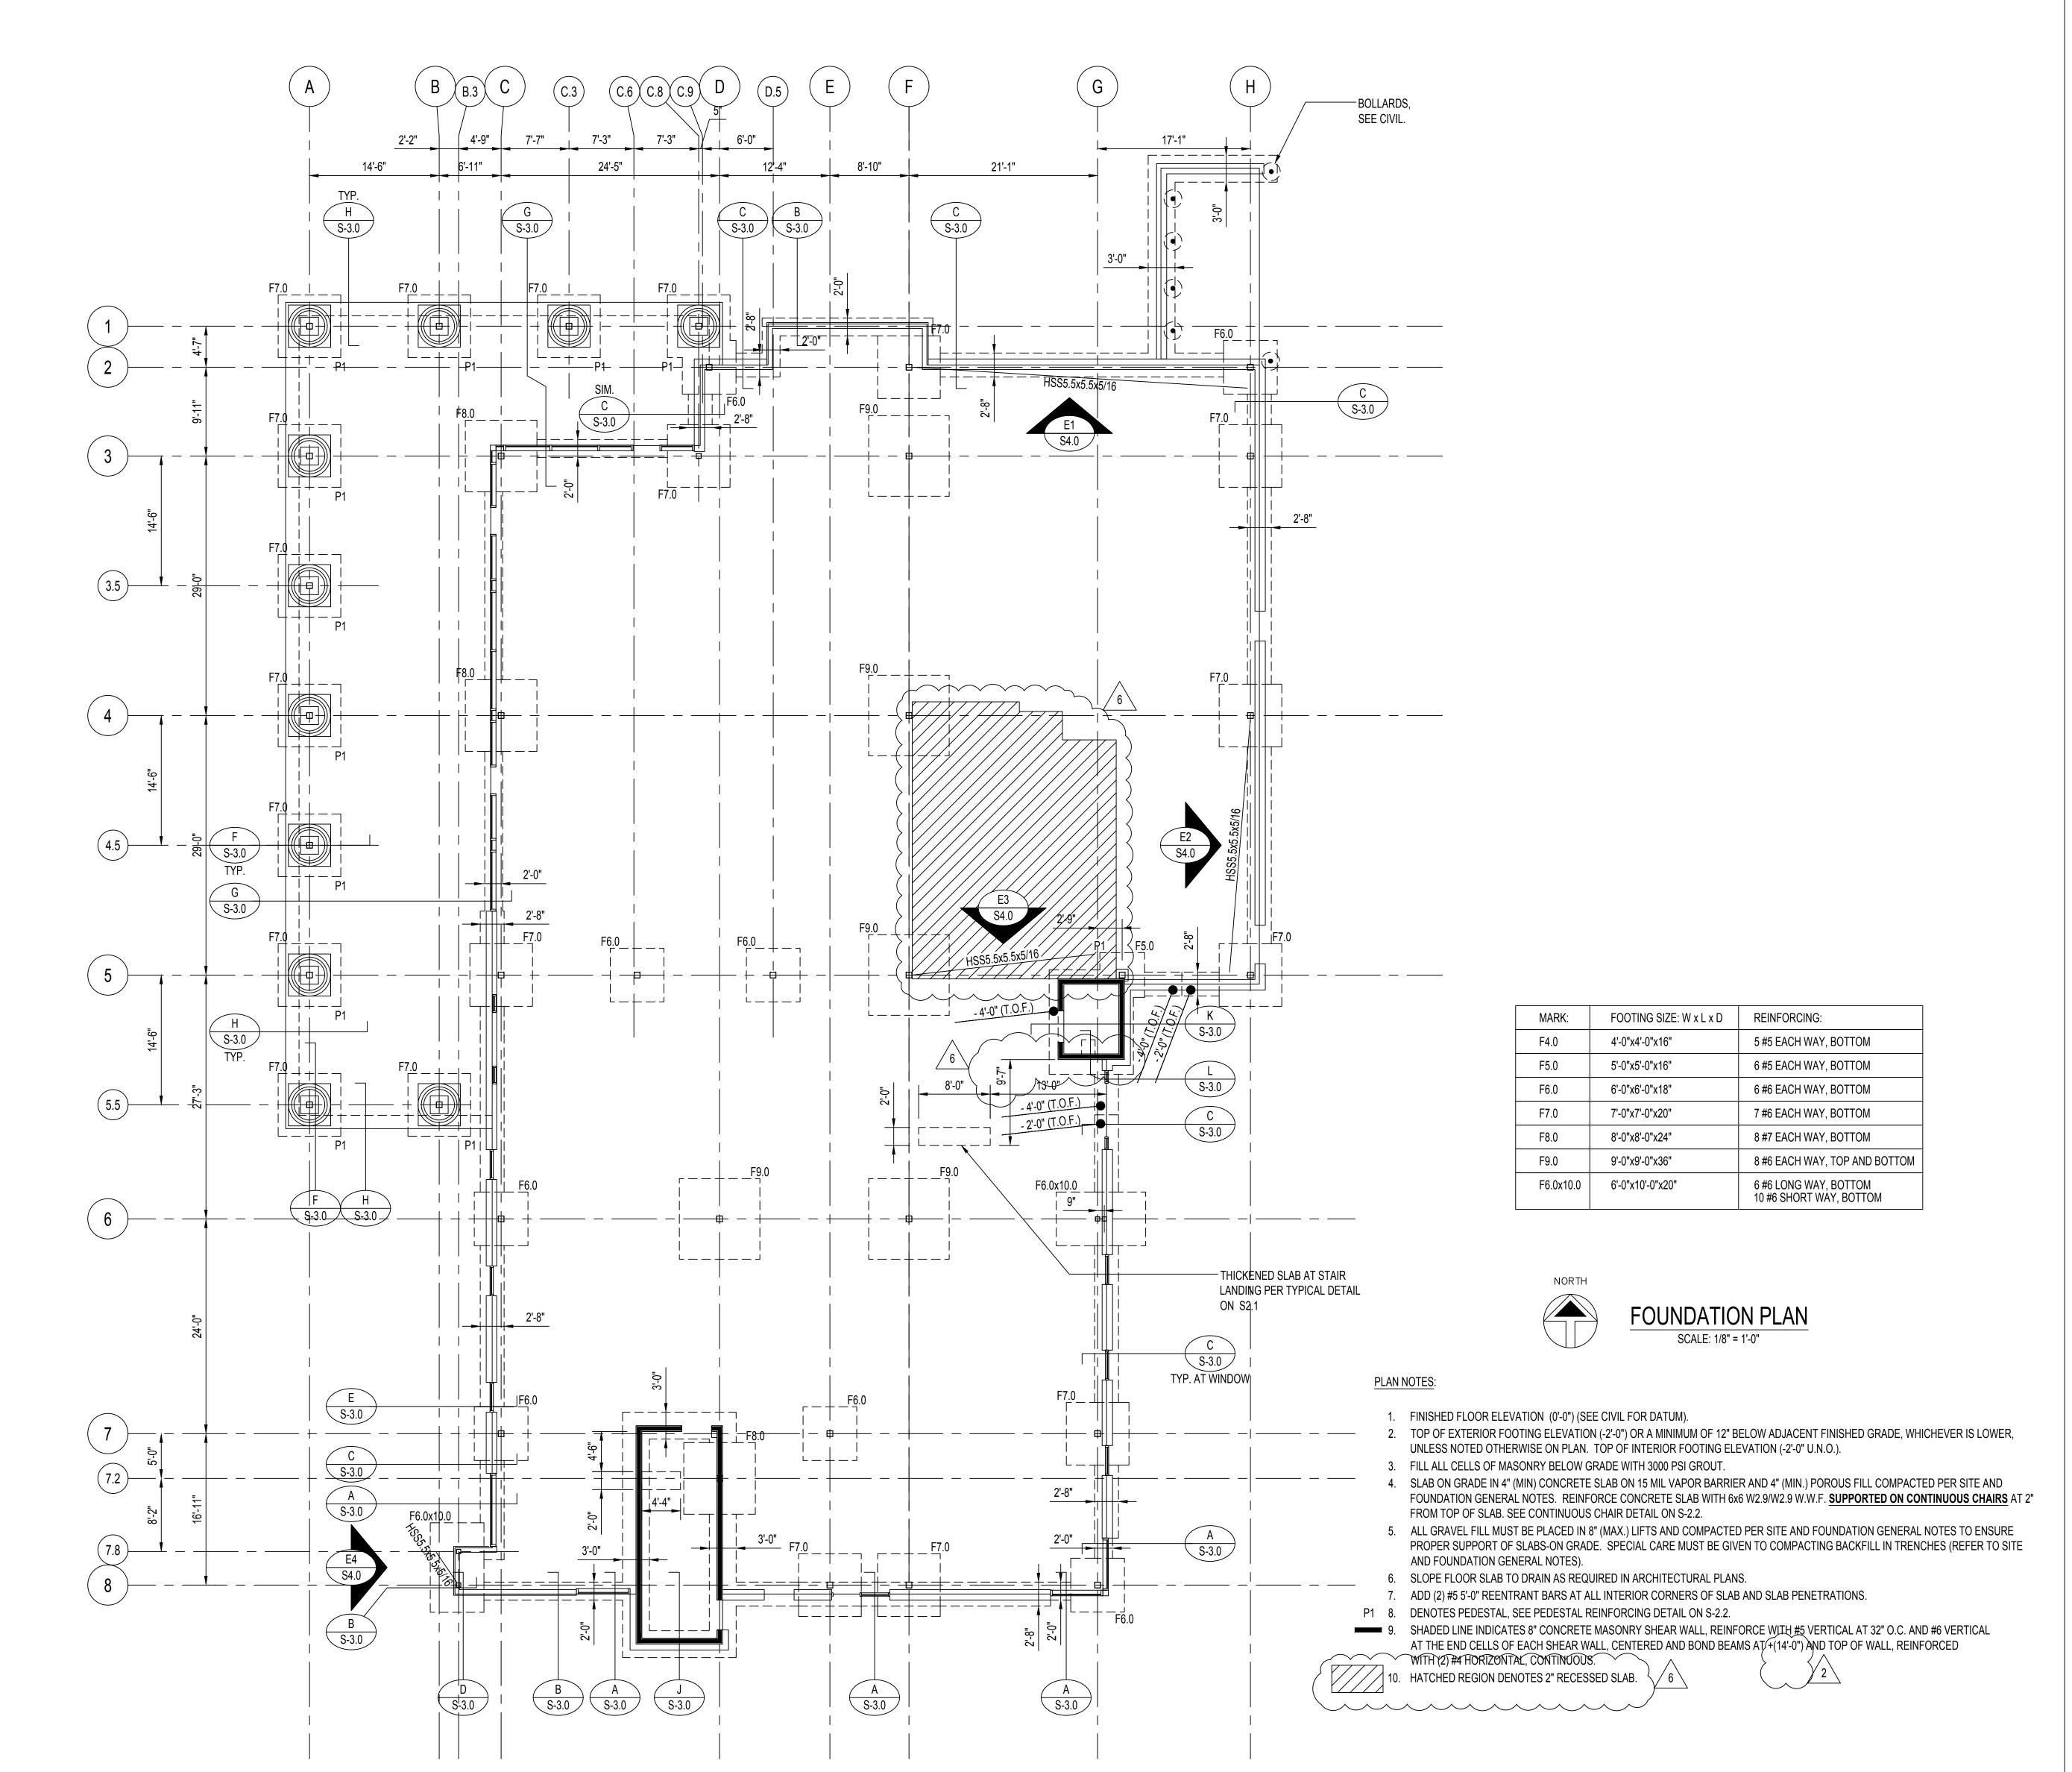
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ADDENDUM 5 3/31/2021 ADDENDUM 6 4/1/2021

SHEET TITLE WALL SECTIONS

SHEET NUMBER A-7.4







JOB NUMBER


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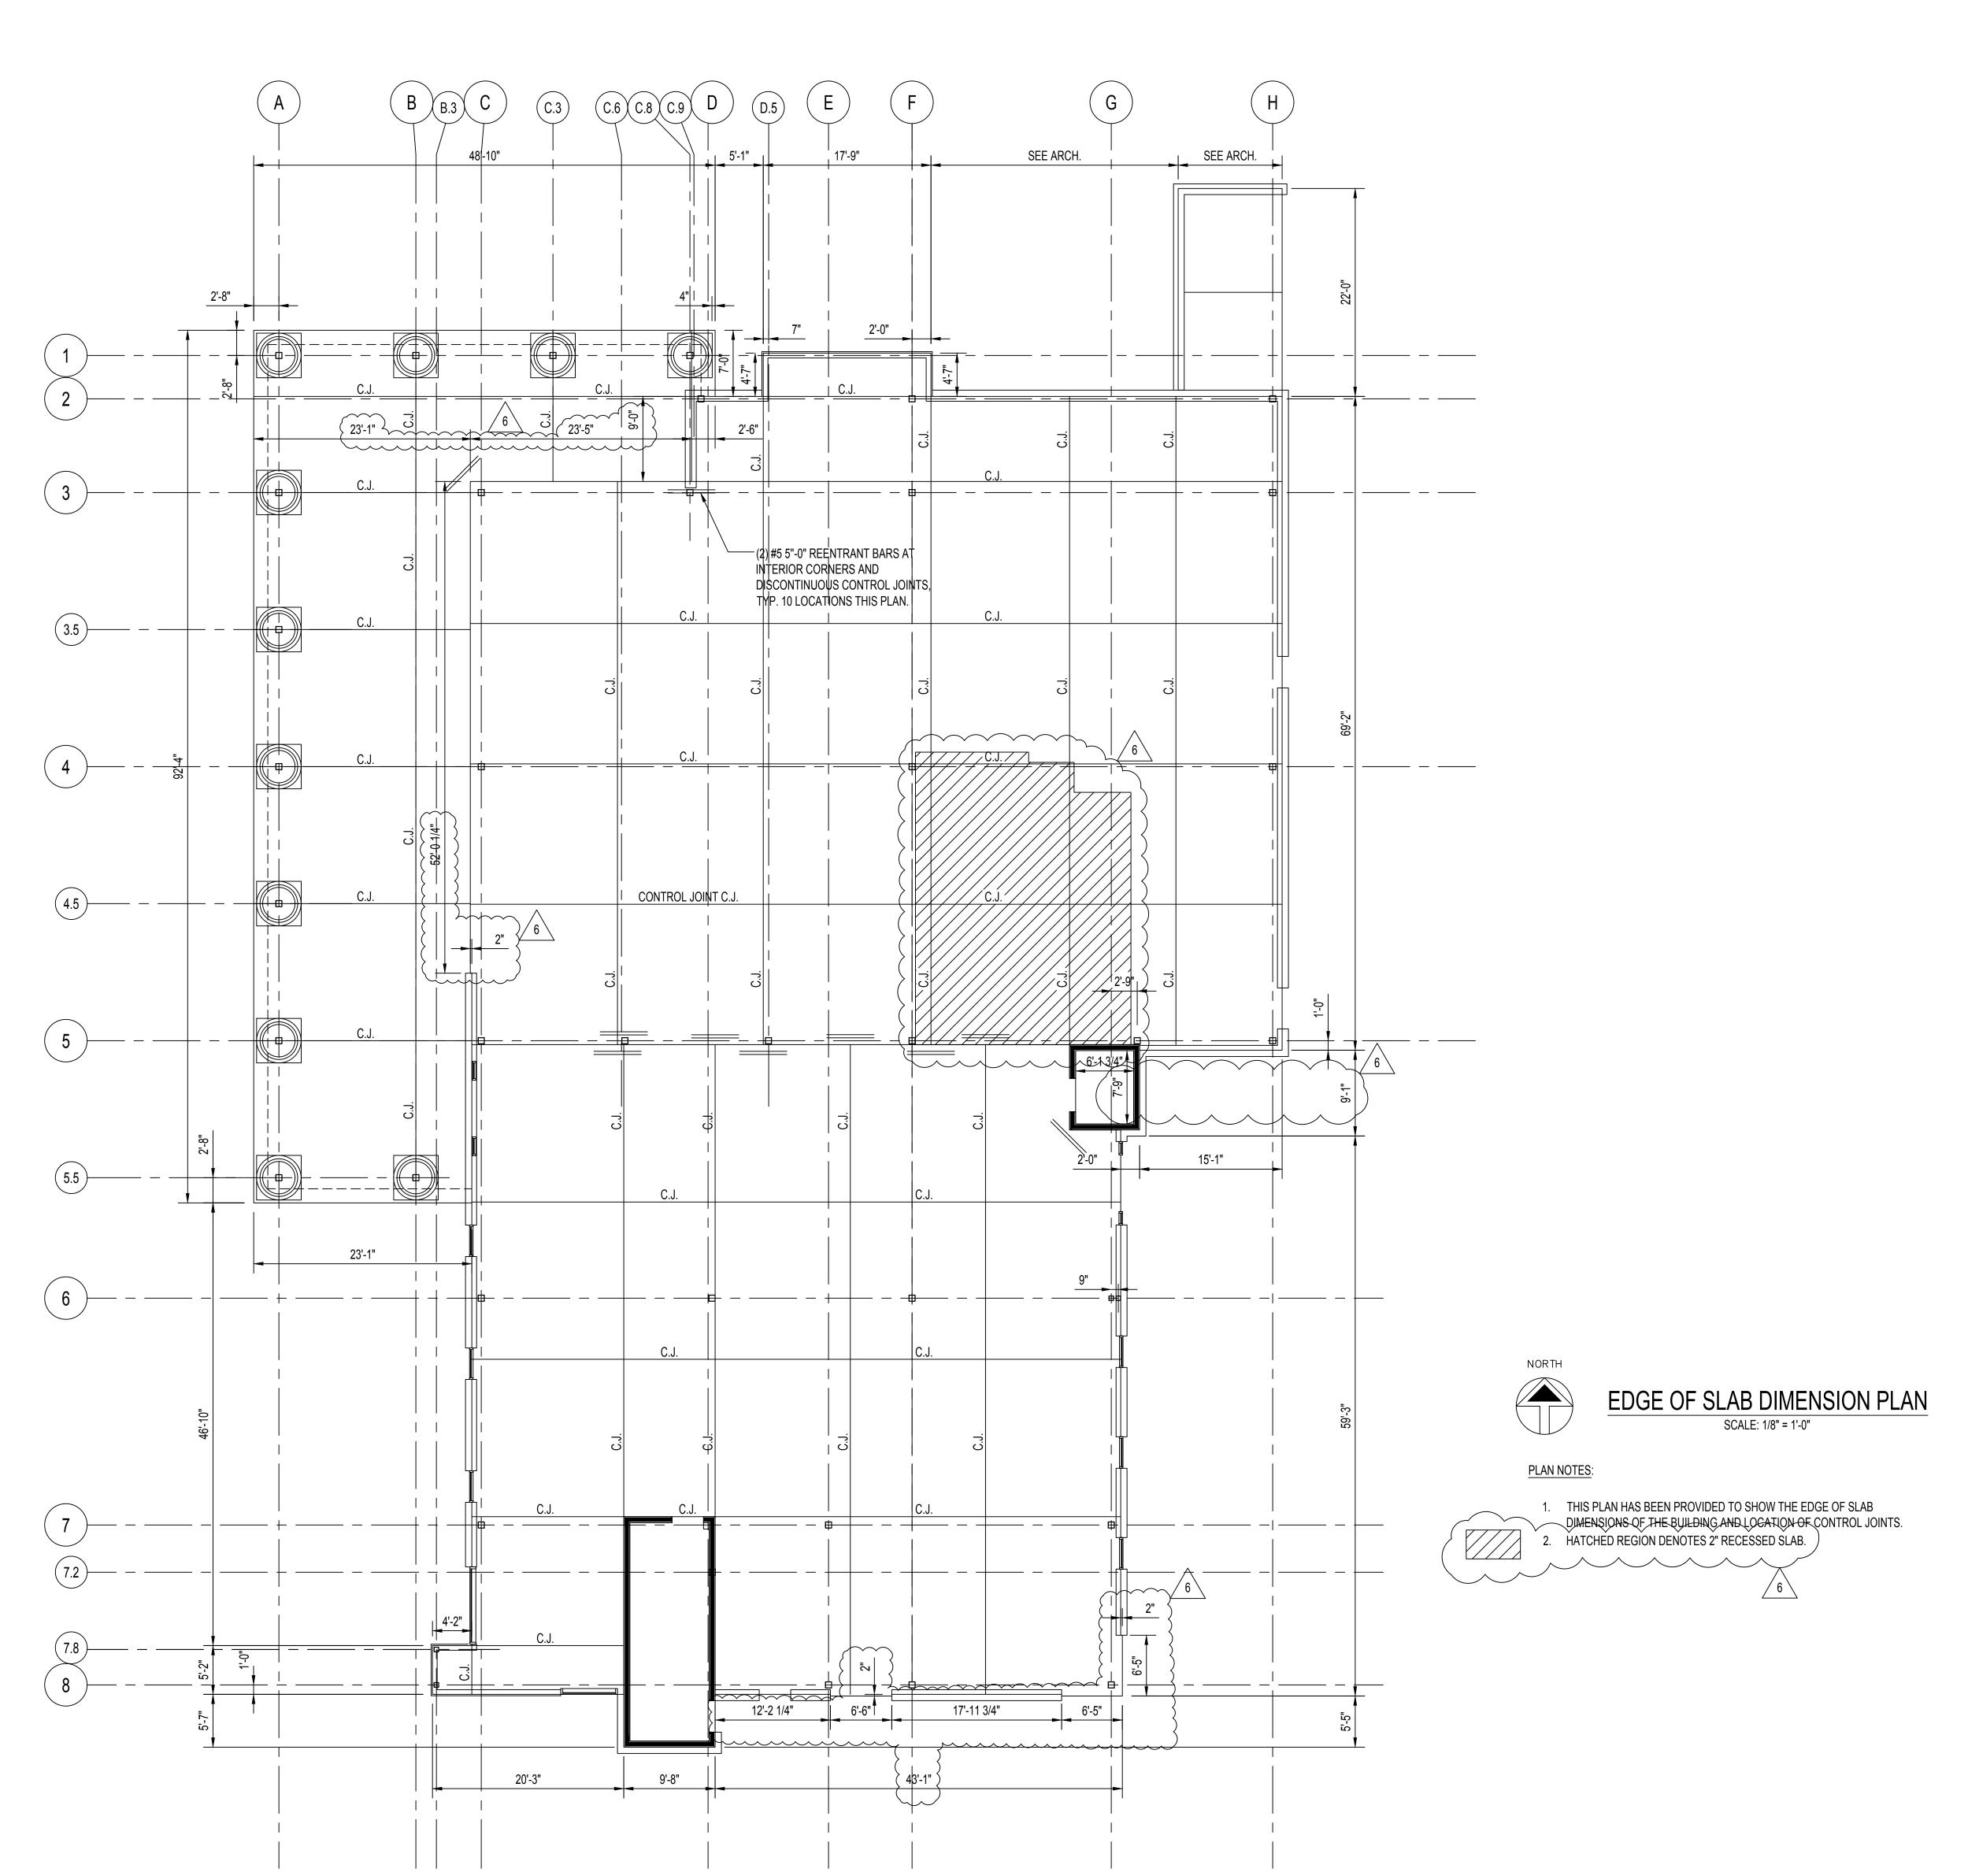
No. Description 2 Elevated Slab Conn. 2/12/21 Slabs

SHEET TITLE FOUNDATION PLAN

SHEET NUMBER





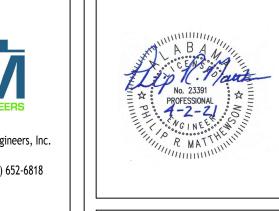

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6 Slabs 4/2/21

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SLAB ON


GRADE PLAN.

S-1.0A

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JOB NUMBER

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FLOOR FRAMING PLAN

SCALE: 1/8" = 1'-0"

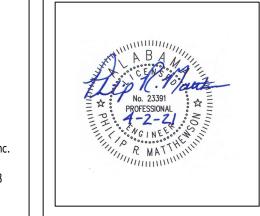3. ALL ROOF DECK TO BE 1 1/2" TYPE B, 22GA GALVANIZED STEEL DECK. CONNECT TO JOISTS WITH 5/8" PUDDLE WELDS IN A 36/4 PATTERN.

5. PROVIDE ANGLE FRAMES AT ALL ROOF TOP MECHANICAL UNITS AND AT ALL ROOF PENETRATIONS. REFER TO TYPICAL DETAIL ON S-2.2.

2. ROOF FRAMING TO BE STEEL JOISTS AS INDICATED AT 3'-0" O.C., UNLESS NOTED OTHERWISE.

4. ROOF JOIST BRIDGING PER S.J.I. SPECIFICATIONS. JOIST BRIDGING SHOWN IS APPROXIMATE.


SIDE LAP FASTENERS TO BE #10 TEK SCREWS. PROVIDE (4) SIDE LAP FASTENERS PER SPAN.

2 Elevated Slab Conn. 2/12/21

SHEET TITLE

FLOOR FRAMING AND LOW ROOF FRAMING PLAN

SHEET NUMBER

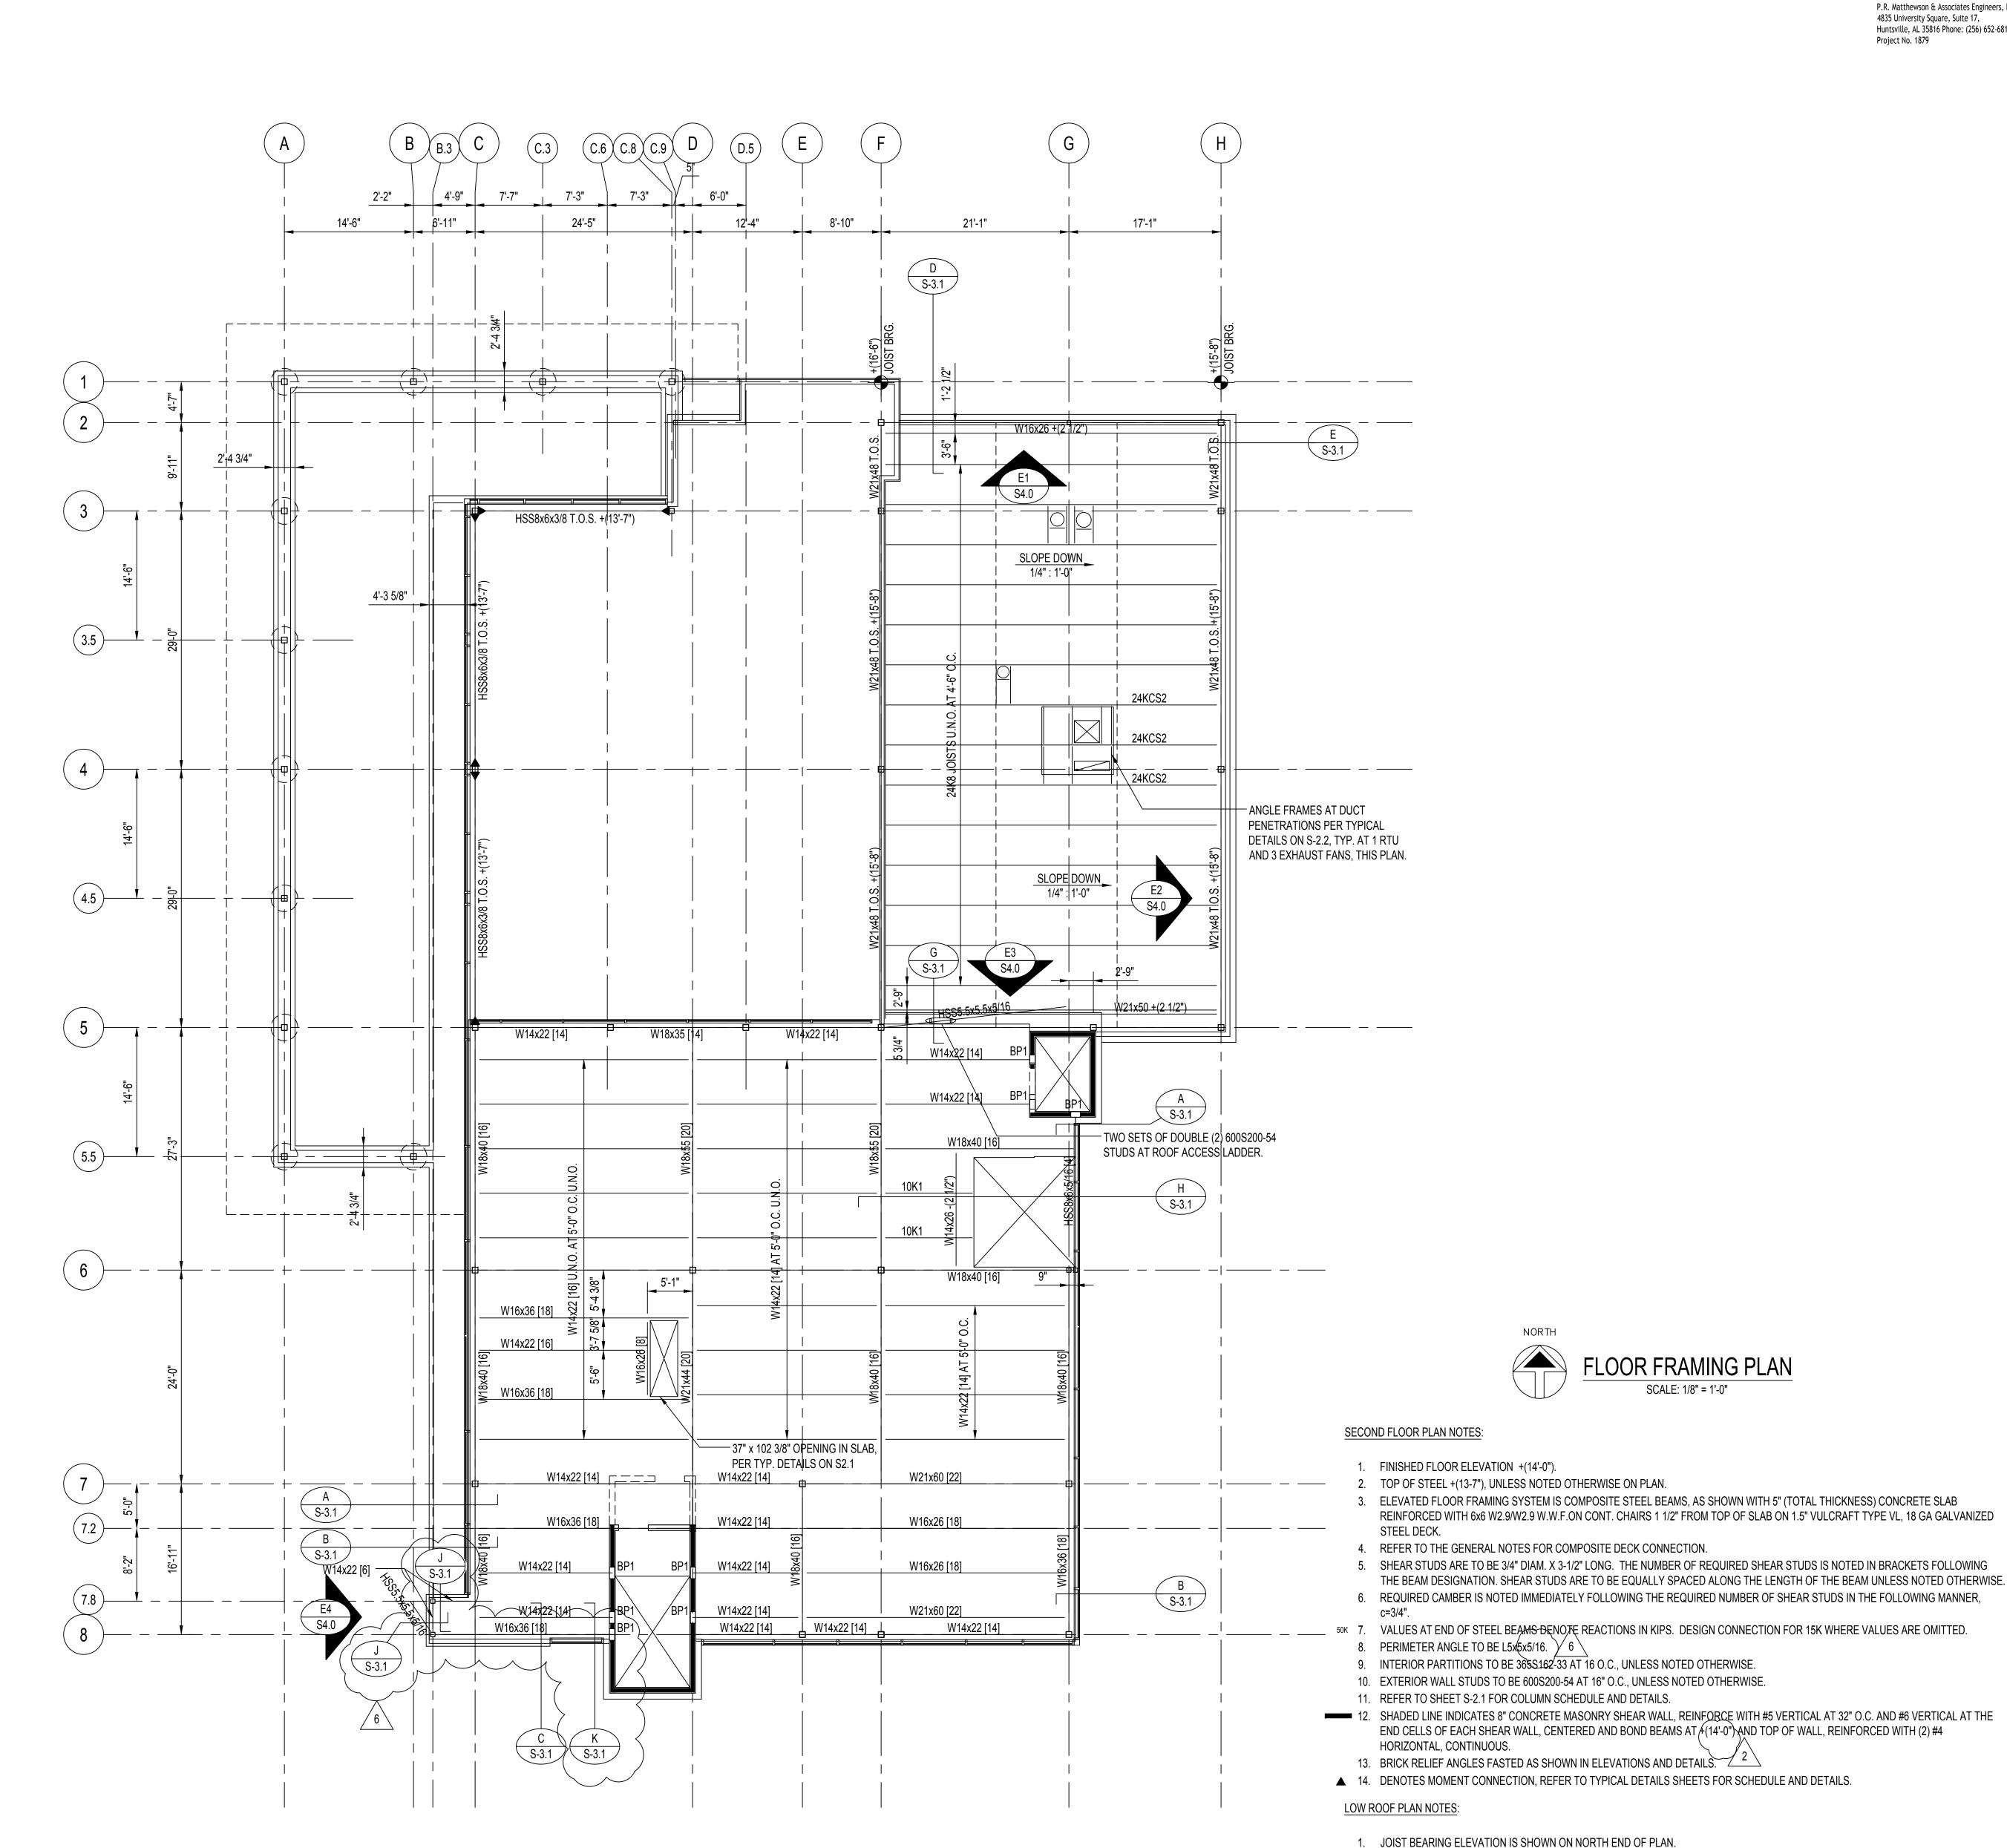





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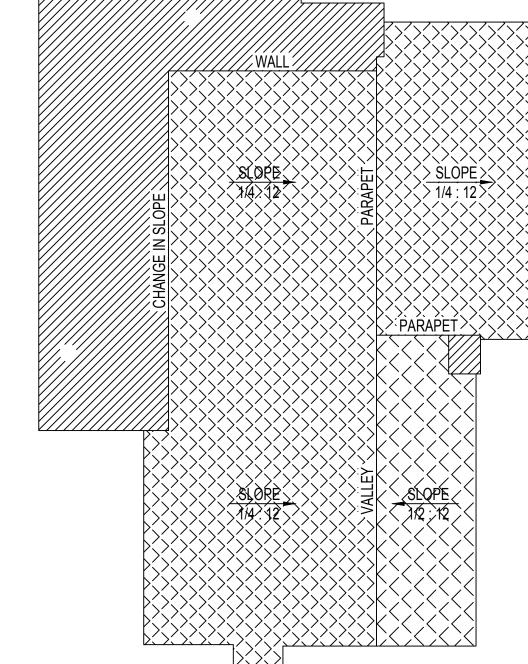
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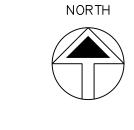
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ROOF FRAMING PLAN

SHEET NUMBER

P.R. Matthewson & Associates Engineers, Inc. Huntsville, AL 35816 Phone: (256) 652-6818 Project No. 1879






ROOF SLOPE FRAMING PLAN


ROOF SLOPE FRAMING PLAN NOTES:


- 1. THIS PLAN INDICATES WHERE THE ROOF STRUCTURE IS SLOPED OR LEVEL.
- 2. THIS PLAN DOES NOT SHOW TAPERED INSULATION, SEE ARCHITECTURAL ROOF DRAWINGS.
- 3. THIS PLAN DOES NOT SHOW CRICKETS NOR ROOF DRAINS, SEE MEP DRAWINGS.

ROOF FRAMING PLAN SCALE: 1/8" = 1'-0"

- 1. TOP OF STEEL ELEVATION IS +(27'-2") UNLESS NOTED OTHERWISE.
- ROOF FRAMING TO BE STEEL JOISTS AS INDICATED AT 5'-0" O.C., UNLESS NOTED OTHERWISE.
- 3. ALL ROOF DECK TO BE 1 1/2" TYPE B, 22GA GALVANIZED STEEL DECK, EXCEPT IN HATCHED REGION (SEE NOTE 4 BELOW). CONNECT TO SUPPORTING STRUCTURE WITH 5/8" PUDDLE WELDS IN A 36/4 PATTERN. SIDE LAP FASTENERS TO BE #10 TEK SCREWS. PROVIDE (4) SIDE LAP FASTENERS PER SPAN.
- 4. HATCHED REGION DENOTES ROOF DECK TO BE 1 1/2" TYPE B, 22GA GALVANIZED ACOUSTIC STEEL DECK. CONNECT TO SUPPORTING STRUCTURE AS DESCRIBED IN NOTE 3 ABOVE. HATCHED REGION IS BOUNDED BY COLUMN LINES 3 AND 5 (N-S DIRECTION) AND C AND F (E_W DIRECTION)
- 5. ROOF JOIST BRIDGING PER S.J.I. SPECIFICATIONS. JOIST BRIDGING SHOWN IS APPROXIMATE.
- 6. PROVIDE ANGLE FRAMES AT ALL ROOF TOP MECHANICAL UNITS AND AT ALL ROOF PENETRATIONS. REFER TO TYPICAL DETAIL
- 7. TOP OF MASONRY VENEER, TOP OF STEEL TUBE AND TOP OF PARAPET TO BE +20'-0".
- 8. SHADED LINE INDICATES 8" CONCRETE MASONRY SHEAR WALL, REINFORCE WITH #5 VERTICAL AT 32" O.C. AND #6 VERTICAL AT THE END CELLS OF EACH SHEAR WALL, CENTERED AND BOND BEAMS A(T+(14'-0")) AND TOP OF WALL, REINFORCED WITH (2) #4
 - HORIZONTAL, CONTINUOUS.
- 9. DENOTES MOMENT CONNECTION, REFER TO TYPICAL DETAILS SHEETS FOR SCHEDULE AND DETAILS. ▲ 10. DENOTES MOMENT CONNECTION AT DROPPED GIRDER, SEE TYPICAL DETAILS SHEETS FOR SCHEDULE AND DETAILS.

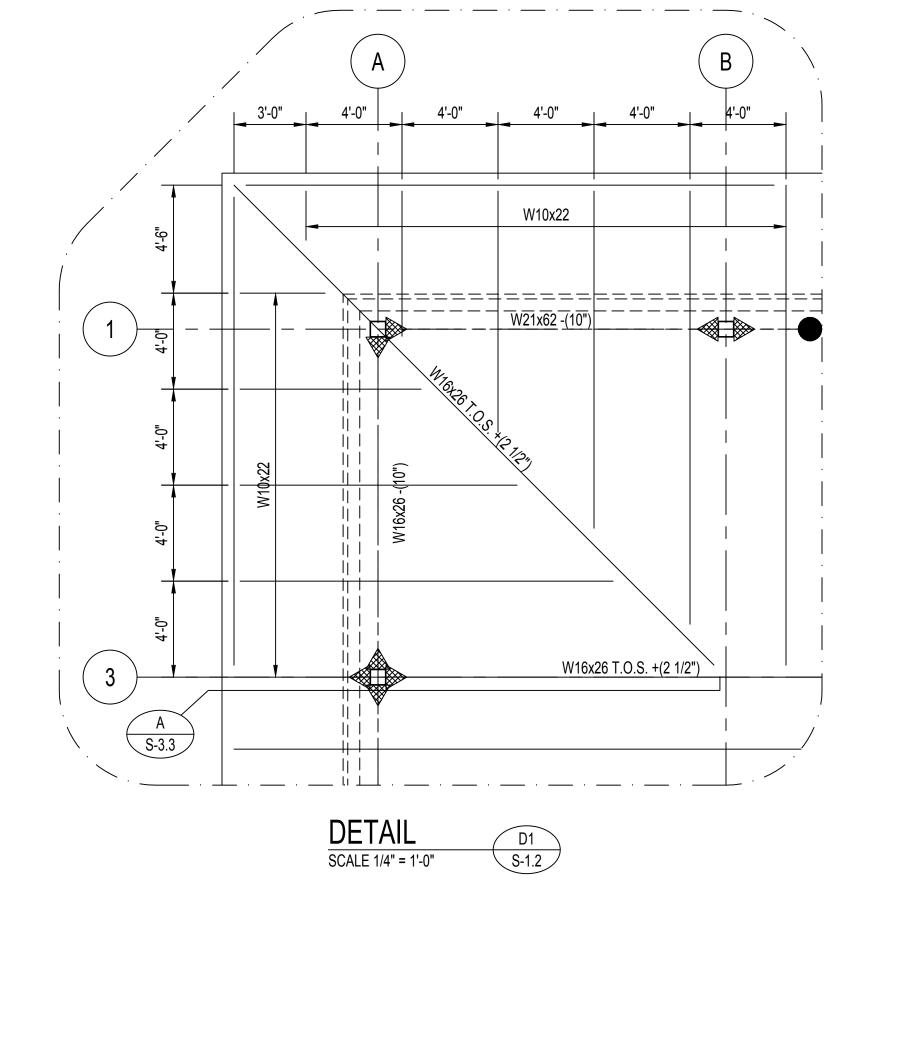

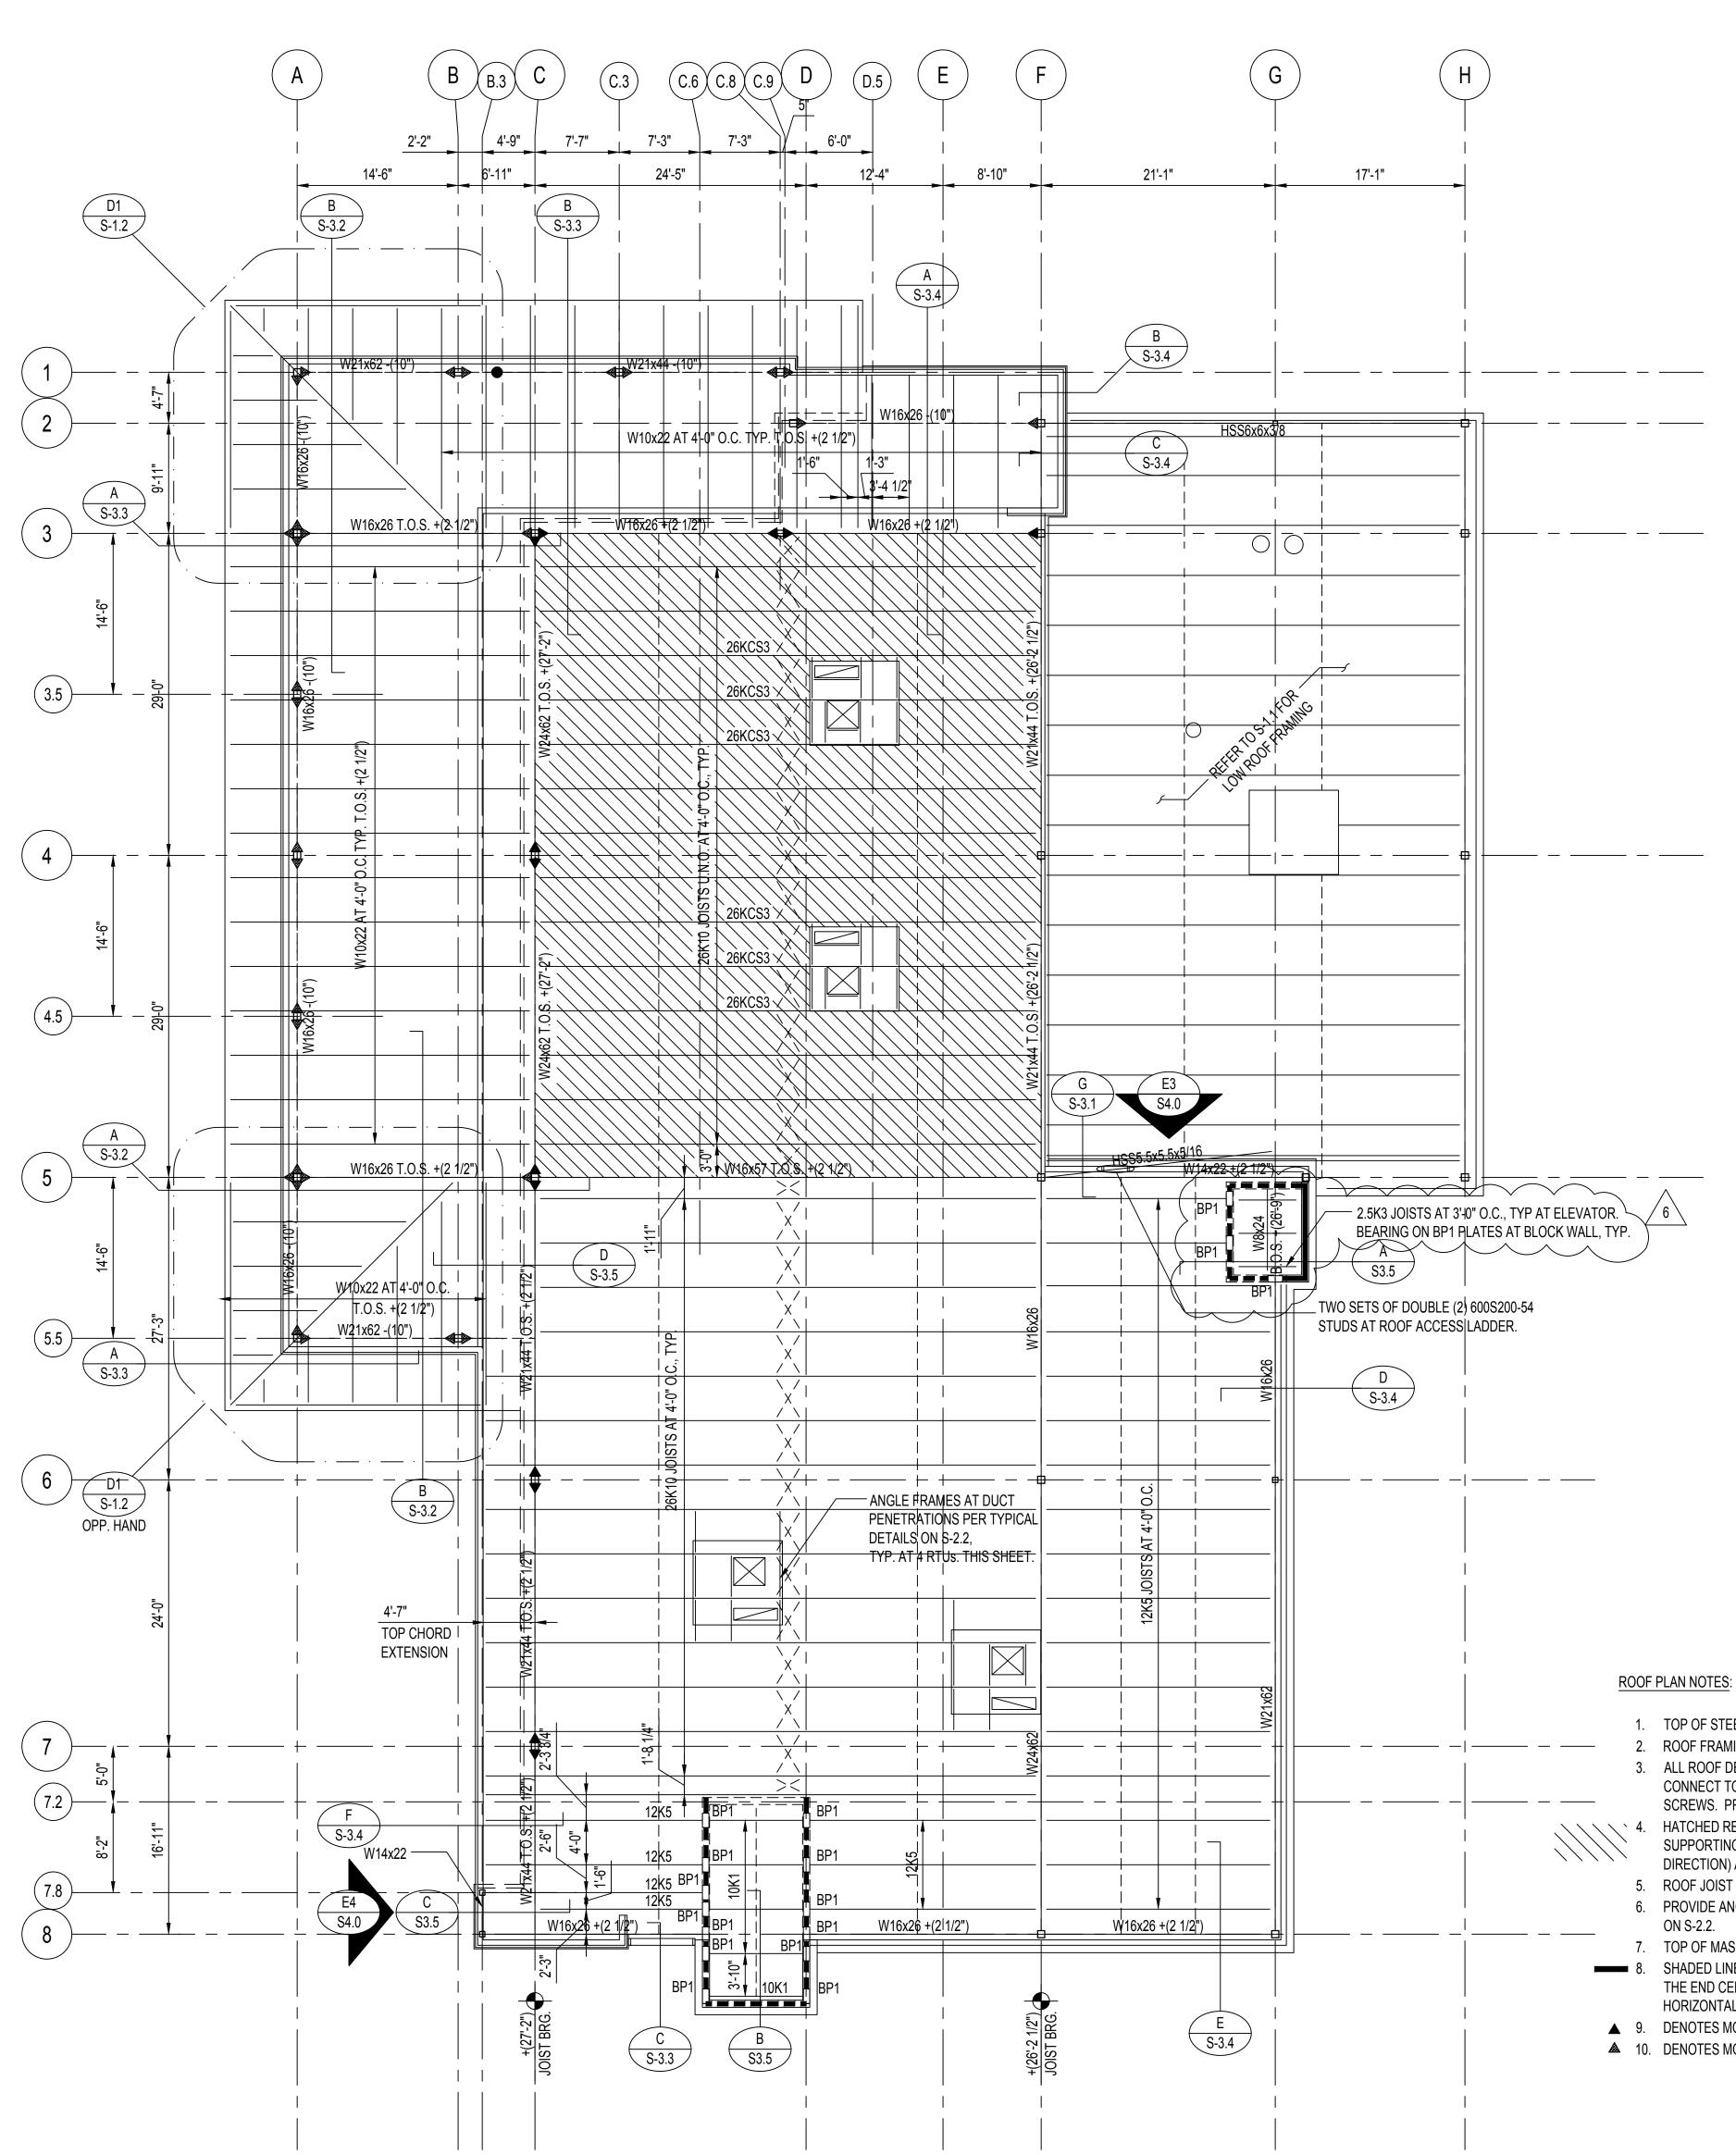

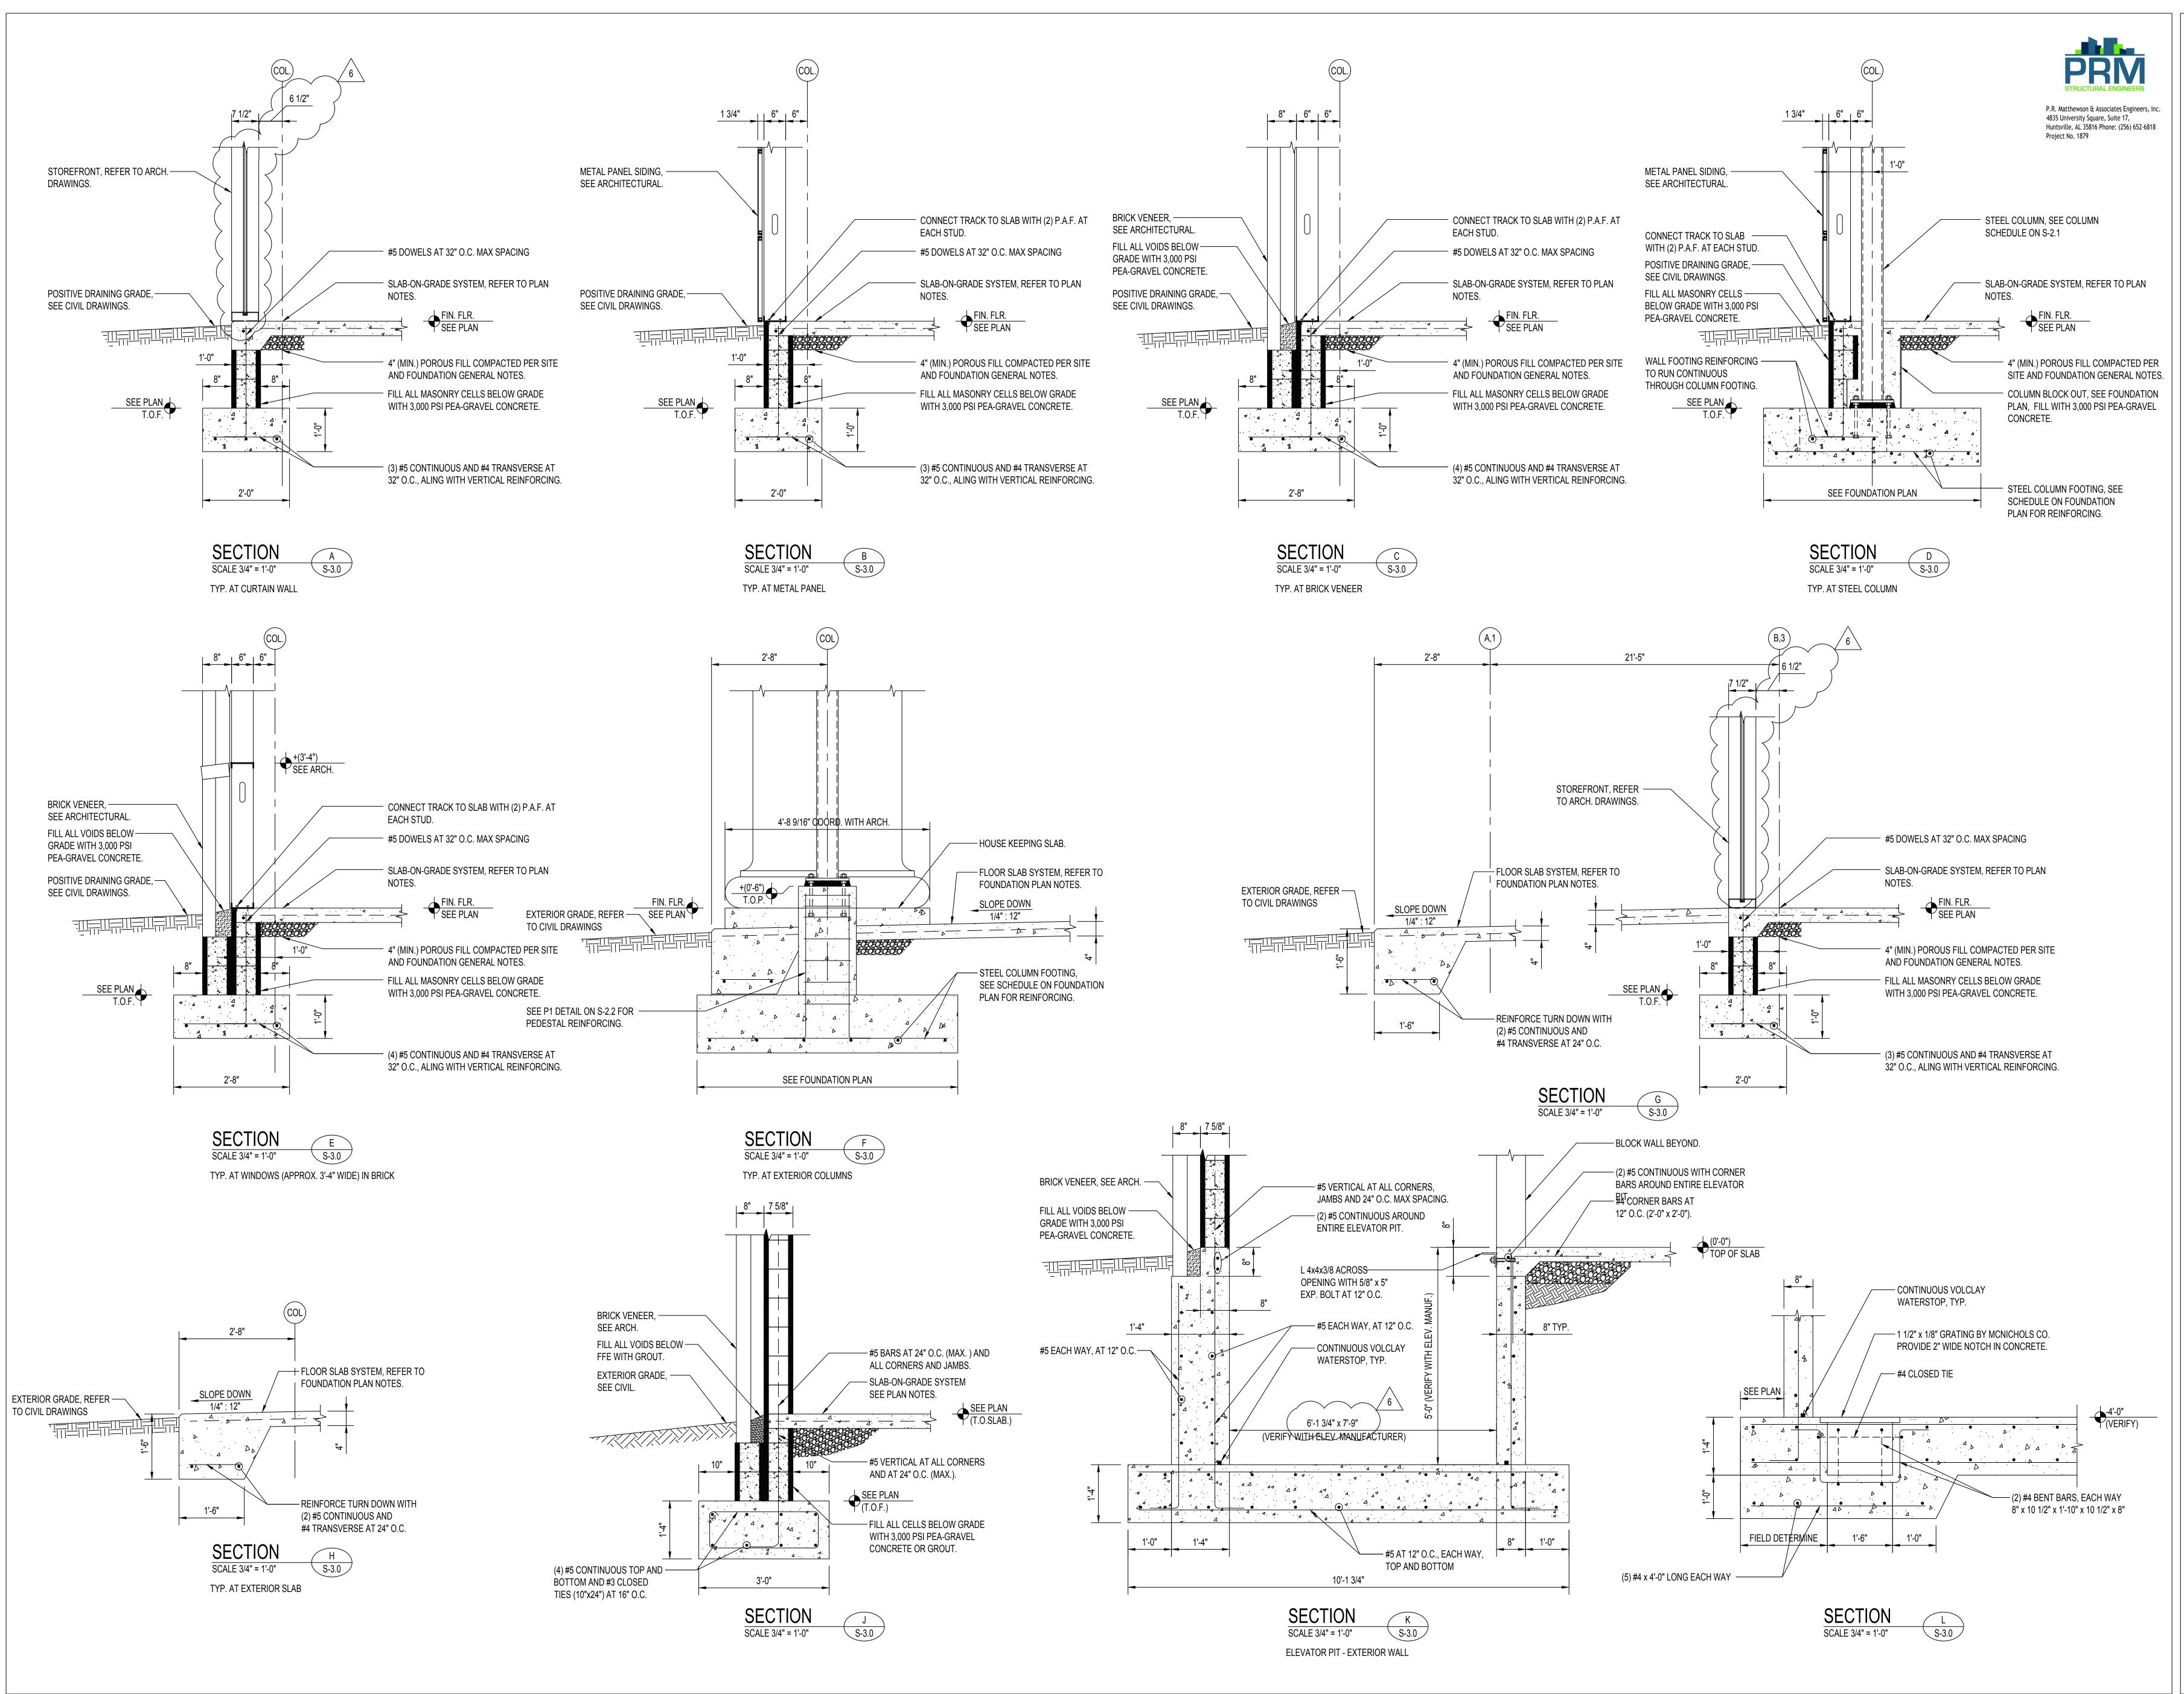



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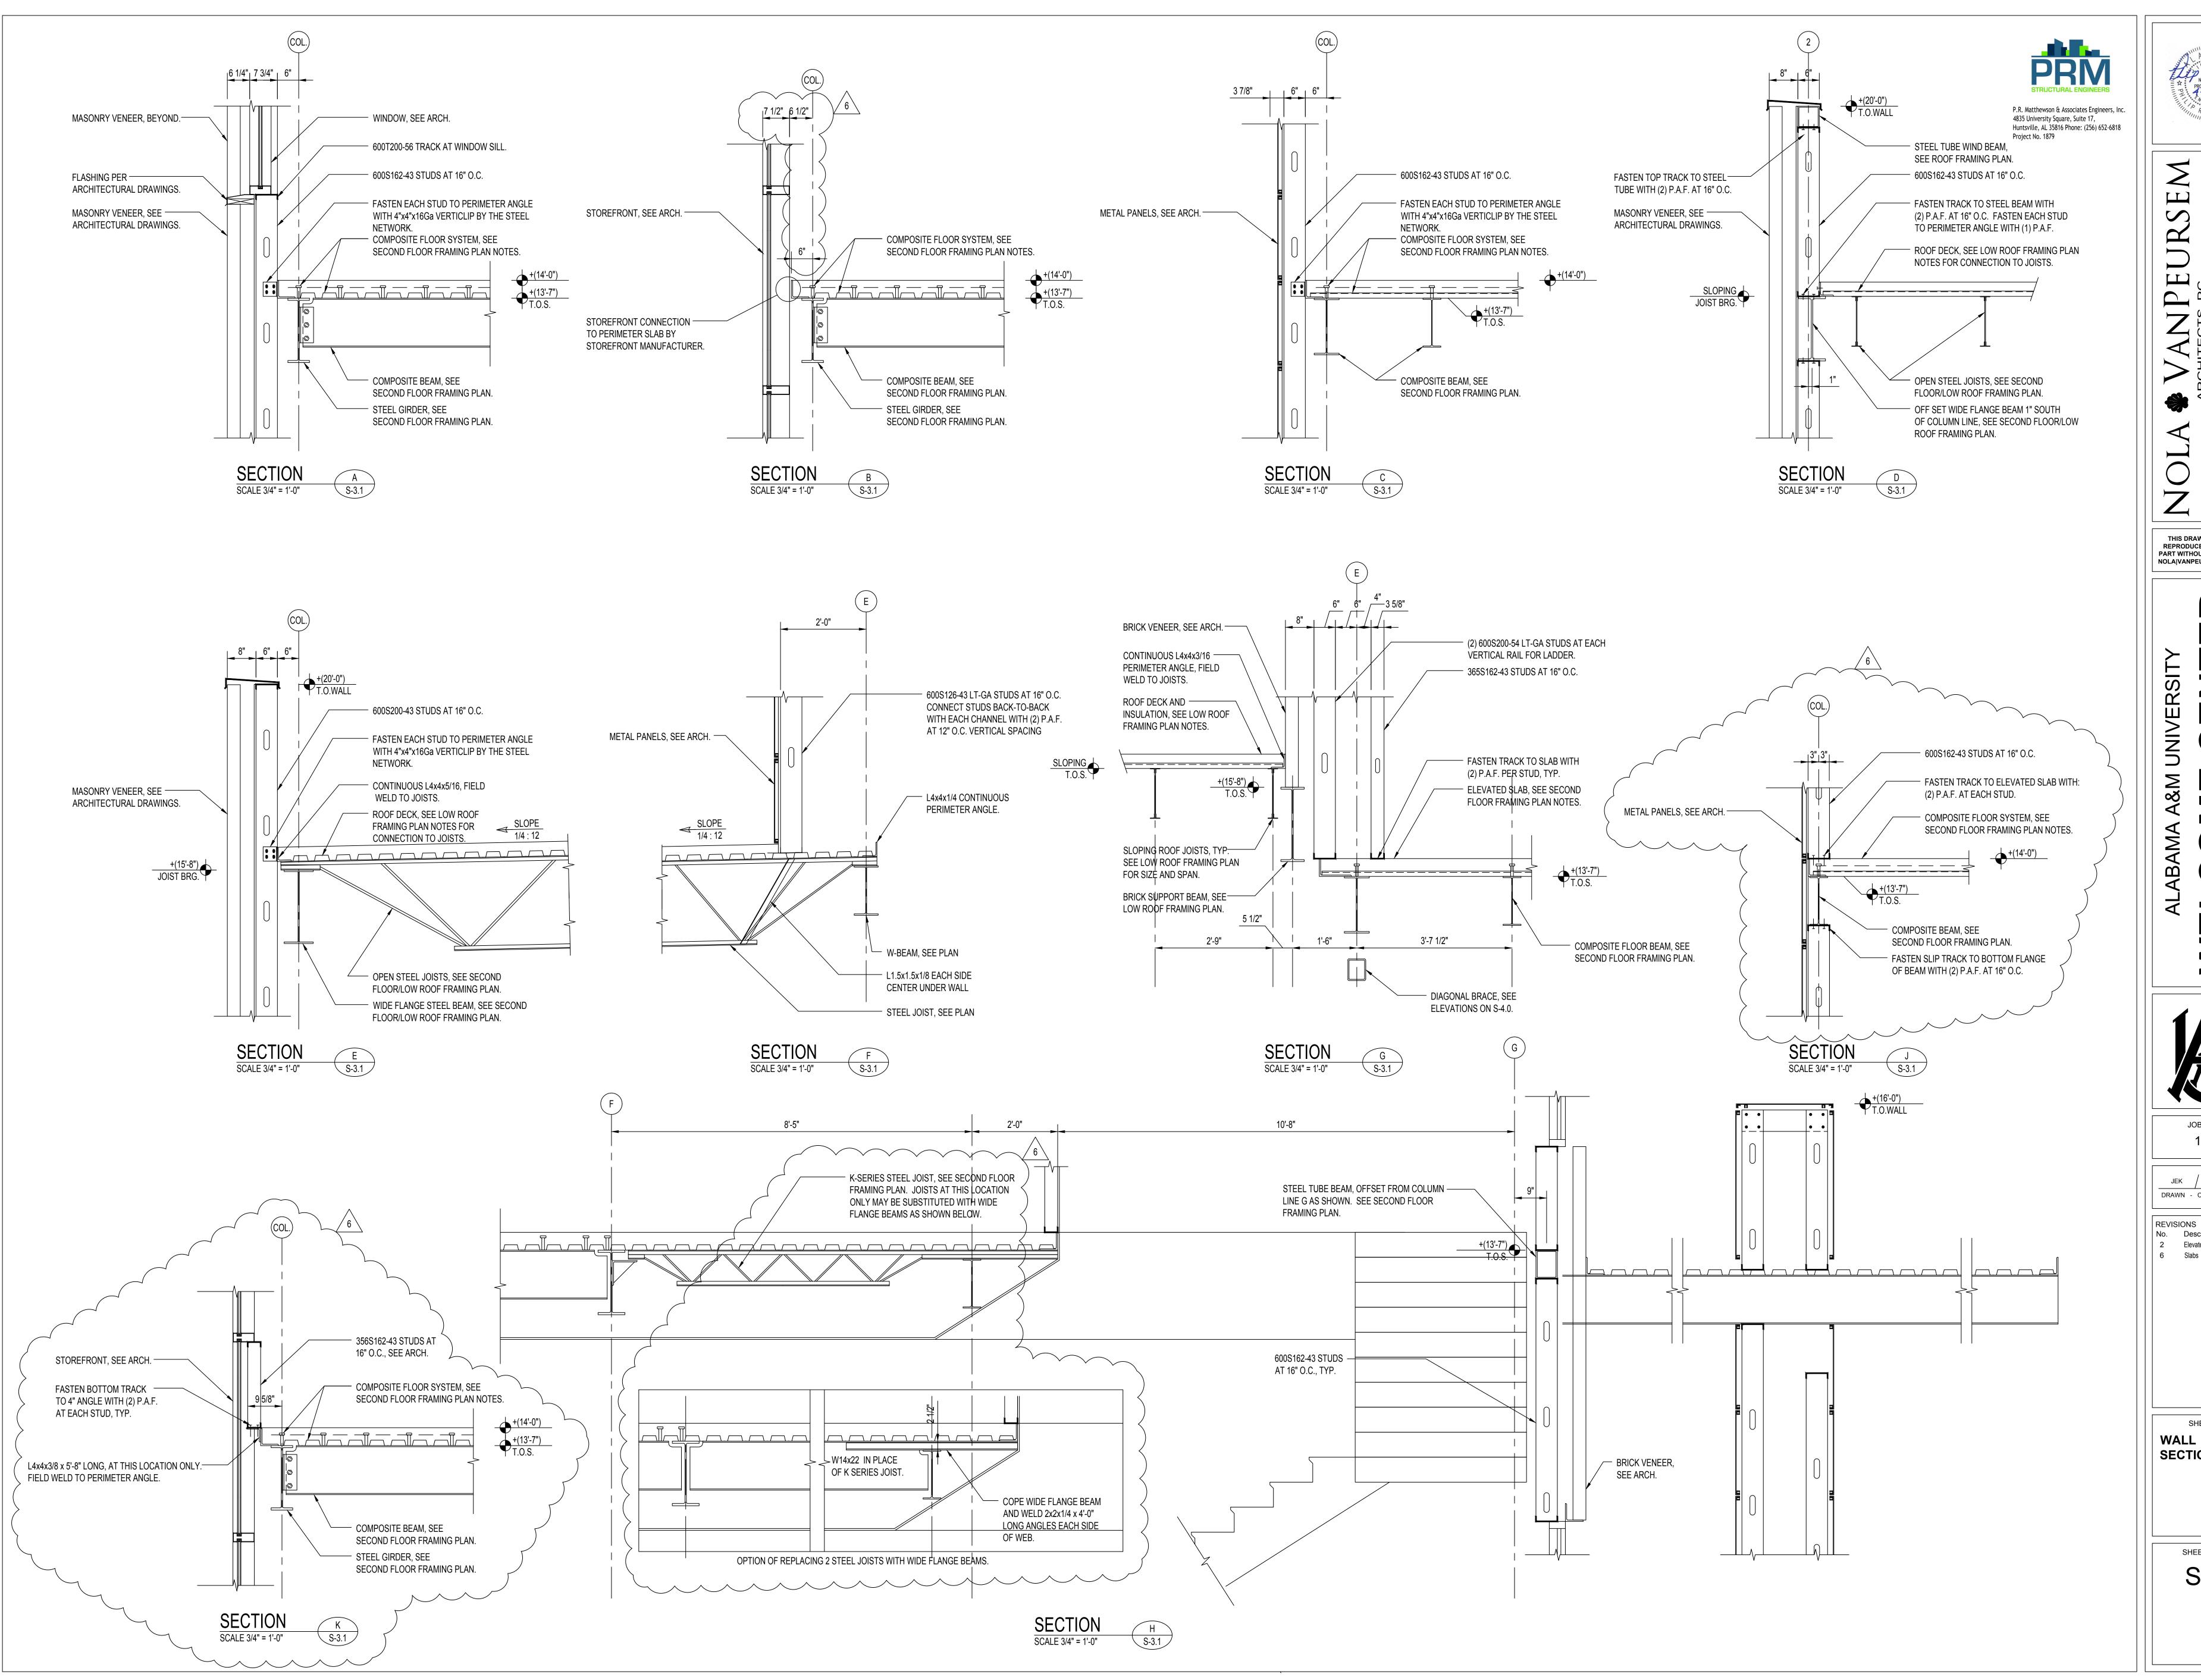
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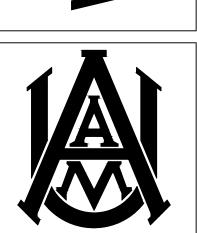
SHEET TITLE

FOUNDATION SECTIONS

> SHEET NUMBER S-3.0







JOB NUMBER

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No. Description 2 Elevated Slab Conn. 2/12/21 6 Slabs

SHEET TITLE

SECTIONS


SHEET NUMBER S-3.1

ELECTRICAL LEGEND


- SURFACE OR RECESSED CEILING OUTLET FIXTURE TYPE '#' CEILING OUTLET - FIXTURE SINGLE OR CONTINUOUS LENGTHS
- CEILING OUTLET FIXTURE SINGLE OR CONTINUOUS LENGTHS CONNECTED TO EMERGENCY INVERTER OR INTEGRAL BATTERY. CEILING OUTLET - FIXTURE SINGLE OR CONTINUOUS LENGTHS
- CEILING OUTLET FIXTURE SINGLE OR CONTINUOUS LENGTHS CONNECTED TO EMERGENCY INVERTER OR INTEGRAL BATTERY
- SINGLE SIDE EXIT SIGN WITH DIRECTIONAL CHEVRONS AS SHOWN.
- DOUBLE SIDE EXIT SIGN WITH DIRECTIONAL CHEVRONS AS SHOWN.
- CEILING OR WALL MOUNTED EMERGENCY LIGHT, BATTERY BACKUP.
- O- SITE POLE SEE PLANS, SCHEDULES, AND DETAILS FOR ADDITIONAL LIGHTING CONTROL DEVICES/INFORMATION

- POWER PANEL SEE SCHEDULE AND SPECIFICATIONS
- RECESSED MOUNTED POWER PANEL SEE SCHEDULE AND SPECIFICATIONS, PROVIDE 4 EA. 1" EMPTY CONDUIT TO ABOVE CEILING FOR FUTURE USE.
- LIGHTING PANEL SEE SCHEDULE AND SPECIFICATIONS
- RECESSED MOUNTED LIGHTING PANEL SEE SCHEDULE AND SPECIFICATIONS, PROVIDE 4 EA. 1" EMPTY CONDUIT TO ABOVE CEILING FOR FUTURE USE.
- TRANSFORMER SEE SCHEDULE AND SPECIFICATIONS, 80°C RISE, FLOOR MOUNTED ON FACTORY
- MOTOR-HORSEPOWER AS SHOWN (HP) HORSEPOWER (TYPICAL)
- FAN CEILING/INLINE/ROOF MOUNTED EXHAUST FAN
- FUSIBLE PULLOUT TYPE DISCONNECT SWITCH SEE SPECIFICATIONS FOR IDENTIFICATION.
- FUSED DISCONNECT SWITCH 600V HEAVY DUTY TYPE, RATING AND ENCLOSURE AS SHOWN. SEE SPECIFICATIONS FOR IDENTIFICATION. FURNISH AND INSTALL NAME PLATES PER DETAIL. FUSE PER EQUIPMENT MANUFACTURER.
- NON-FUSED DISCONNECT SWITCH 600V HEAVY DUTY TYPE, RATING AND ENCLOSURE AS SHOWN. SEE SPECIFICATIONS FOR IDENTIFICATION. FURNISH AND INSTALL NAME PLATES
- CIRCUIT BREAKER WITH ENCLOSURE (BREAKER SIZE AS INDICATED) 600V RATING AND ENCLOUSURE AS SHOWN SEE SPECIFICATIONS. FOR IDENTIFICATION. FURNISH AND INSTALL
- MANUAL MOTOR STARTER HORSEPOWER RATED, WITH THERMAL OVERLOAD UNITS AND ENCLOSURE CONSISTENT WITH ENVIRONMENT.
- VARIABLE FREQUENCY DRIVE FURNISHED BY MECHANICAL SEE PLANS
- METER ENCLOSURE AND MASTER METER FOR INDIVIDUAL CIRCUIT METERS ON BREAKERS. SEE PLANS
- 2) HD EXCEL HAND DRYER, MODEL: XLERATOR (OR PRE-APPROVED EQUAL), 120 VAC, STAINLESS STEEL FINISH, MOUNTED ON 4" SQUARE BOX WITH SINGLE GANG RAISED COVER HEIGHT PER ADAAG LATEST EDITION. COORDINATE WITH OWNER/ARCHITECT THE MODEL OF HAND DRYER PRIOR TO ANY/ALL ORDERING.
- STUB UP TO PRE-WIRED FURNITURE. CONCEAL CONDUCTORS IN CHASE OF FURNITURE. COORDINATE WITH APPROVED FURNITURE SUBMITTALS PRIOR TO
- JUNCTION BOX WITH FLEXIBLE CONNECTION TO MOTORIZED DAMPER; 120V
- SEE MECHANICAL PLANS. JUNCTION BOX WITH FLEXIBLE CONNECTION TO MOTORIZED SCREEN; 120V
- JUNCTION BOX WITH FLEXIBLE CONNECTION TO EQUIPMENT. SEE PLANS.
- DC JUNCTION BOX WITH FLEXIBLE CONNECTION TO DOOR CONTROLLER. 120V.
- CEILING MOUNTED JUNCTION BOX. SEE PLANS.
- WALL MOUNTED JUNCTION BOX. SEE PLANS.
- EMERGENCY GAS SHUT-OFF, SEE PLANS AND DETAILS.
- JUNCTION BOX WITH FLEXIBLE CONNECTION TO DOOR CONTROLLER OR MOTORED DOOR OPERATOR; 120V


HOMERUN TO PANELBOARD - #10 AWG WIRE WITH NEC CODE AND CONDUIT PER NEC FILL. HOMERUN TO PANELBOARD - ANY CIRCUIT WITHOUT FURTHER DESIGNATION IS 2 NO. 12, 1#12 GRN, 3/4" C. 4 NO. 12, 1#12 GRN, 3/4" C.

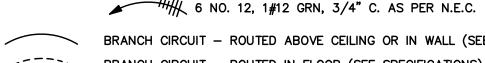

BRANCH CIRCUIT — ROUTED ABOVE CEILING OR IN WALL (SEE SPECIFICATIONS) BRANCH CIRCUIT - ROUTED IN FLOOR (SEE SPECIFICATIONS) BRANCH CIRCUIT - EXPOSED (SEE SPECIFICATIONS).

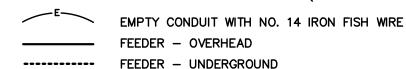

WP INDICATES DEVICE TO BE WEATHER-PROOF

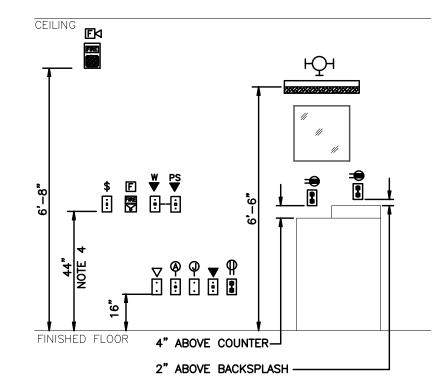

TYPICAL MOUNTING HEIGHTS NOT TO SCALE

NOTES:

- 1. INDICATED MOUNTING HEIGHTS ARE FROM FINISHED FLOOR TO BOTTOM OF OUTLET BOX, UNLESS OTHERWISE NOTED. 2. REFER TO ARCHITECTURAL DETAILS FOR ADDITIONAL REQUIREMENTS.
- 3. INSTALL OUTLETS THAT ARE IN CLOSE PROXIMITY ON THE SAME
- 4. INDICATED DEVICES MOUNTED IN A BLOCK WALL SHALL BE 4'-0" TO TOP OF COVER PLATE.

RECEPTACLES

- DUPLEX RECEPTACLE, NEMA 5-20R, SEE SPECIFICATIONS.
- DUPLEX RECEPTACLE, NEMA 5-20R, SEE SPECIFICATIONS. REFER TO ARCHITECTURAL ELEVATIONS
- DUPLEX RECEPTACLE, NEMA 5-20R, GROUND FAULT INTERRUPTER, WEATHERPROOF. (IN USE TYPE
- DUPLEX RECEPTACLE, 15A., 125V., 2 POLE, 3W., NEMA 5-15R, WITH TWO USB CHARGING PORTS, HUBBELL #USB15X. DUPLEX RECEPTACLE, WEATHER-RESISTANT, 15A., 125V., 2 POLE, 3W., NEMA 5-15R, WITH TWO USB CHARGING PORTS AND WEATHER-PROOF IN-USE COVER.
- DEDICATED DUPLEX RECEPTACLE, NEMA 5-20R, SEE SPECIFICATIONS. DEDICATED QUADRAPLEX RECEPTACLE, NEMA 5-20R, SEE SPECIFICATIONS
- DUPLEX RECEPTACLE, NEMA 5-20R, SELF TEST GROUND FAULT INTERRUPTER, FEED-THRU.
- QUADRAPLEX, NEMA 5-20R WITH SINGLE PLATE.
- ELECTRIC WATER COOLER SIMPLEX RECEPTACLE, NEMA 5-20R, VERIFY EXACT HEIGHT AND LOCATION PRIOR TO INSTALLATION.
- DUPLEX RECEPTACLE, NEMA 5-20R, WITH GROUND FAULT INTERRUPTER, CONNECTION FOR MICROWAVE, COORDINATE MOUNTING HEIGHT WITH ARCHITECTURAL ELEVATIONS.
- DUPLEX RECEPTACLE, NEMA 5-20R, CONNECTION FOR REFRIGERATOR, COORDINATE MOUNTING HEIGHT WITH ARCHITECTURAL ELEVATIONS. DUPLEX RECEPTACLE, NEMA 5-20R, CONNECTION FOR UNDER COUNTER
- REFRIGERATOR, COORDINATE MOUNTING HEIGHT WITH ARCHITECTURAL
- COORDINATE MOUNTING HEIGHT WITH ARCHITECTURAL ELEVATIONS. DUPLEX RECEPTACLE, NEMA 5-20R. MOUNTED IN T.V. CONTROL OUTLET BOX.
- PROVIDE STEEL BARRIER. COORDINATE EXACT MOUNTING HEIGHT WITH ARCHITECTURAL ELEVATIONS.
- MEDIA CONVERTER ENCLOSURE, SEE DETAIL : POLE MOUNTED CAMERA. WALL OUTLET - SINGLE OUTLET, SEE PLANS FOR NEMA CONFIGURATION. VERIFY NEMA

DUPLEX RECEPTACLE, NEMA 5-20R, CONNECTION FOR ICE MACHINE,

- CONTROLLED DUPLEX RECEPTACLE, NEMA 5-20R WITH SINGLE PLATE. RECEPTACLE TO BE PERMANENTLY MARKED BY FACTORY (CONTROLLED). RECEPTACLE TO BE CONTROLLED BY BAS VIA TIME OF DAY SCHEDULING. CONTROL DEVICE TO COMPLY WITH ASHRAE 90.1, 2013. RECEPTACLE HALF SWITCHED. CONTROLLED DOUBLE DUPLEX RECEPTACLE, (2) NEMA 5-20R WITH SINGLE PLATE.
- RECEPTACLE TO BE PERMANENTLY MARKED BY FACTORY (CONTROLLED). RECEPTACLE TO BE CONTROLLED BY BAS VIA TIME OF DAY SCHEDULING. CONTROL DEVICE TO COMPLY WITH ASHRAE 90.1, 2013. RECEPTACLES HALF SWITCHED. RECEPTACLE RF TRANSMITTER - LEGRAND #WRC-TX WITH POWER PACK AND OCCUPANCY SENSOR. COORDINATE WITH MANUFACTURER COVERAGE OF OCCUPANCY SENORS AND PROVIDE

AMOUNT PER MANUFACTURERS SPECIFICATIONS. ALL NEW 120V, 20A, DUPLEX RECEPTACLES TO

BE RF CONTROLLED PLUG-LOAD RECEPTACLES (WIREMOLD# RF26352CHGRY) COMPLETE WITH

PLUG-LOAD SIGNAL PACKS (ONE PER EACH ROOM WITH CONTROLLED RECEPTACLES). RECEPTACLE TO BE MOUNTED IN SOUND REINFORCEMENT ENCLOSURE (LIGHTSPEED

RECEPTACLE CONTROL NARRATIVE

CEILING SPEAKER/ RECEIVER)

ALL OUTLETS/DEVICES MARKED WITH AN "S" TO BE SWITCHED BY AN OCCUPANCY SENSOR PER (ASHRAE 90.1 2013. CHAPTER 8 SECTIONS 8.4.2) COORDINATE WITH THE AHJ FOR THE PROGRAM SCHEDULE FOR CONTROLLED AREAS. PROVIDE MANUAL OVERRIDE FOR ALL OUTLETS/DEVICES PER A MAXIMUM OF 5,000 SQ FT. AND TO STAY ON FOR UP TO 2 HOURS MAXIMUM FOR ALL CONTROLLED AREAS. SEE PLANS AND LEGEND FOR MANUAL OVERRIDE DEVICE AND LOCATIONS.

FLOOR BOXES

 $_{\sim}$ FSC FLOOR OUTLET - (POKE-THRU) - WIREMOLD (RC4ATC) SERIES POKE-THRU ASSEMBLY FOR POWER AND DATA CONNECTIONS, COMPLETE WITH 2 EACH FACTORY PREWIRED 20A DUPLEX RECEPTACLES (ONTROLLED DUPLEX RECEPTACLE, NEMA 5-20R WITH SINGLE PLATE. RECEPTACLE TO BE PERMANENTLY MARKED BY FACTORY (CONTROLLED), RECEPTACLE TO BE CONTROLLED BY BAS VIA TIME OF DAY SCHEDULING. CONTROL DEVICE TO COMPLY WITH ASHRAE 90.1, 2013.) AND TWO EACH CAT6 RJ45 COMMUNICATION CONNECTORS. FURNISH AND INSTALL (COM75) COMMUNICATION CONDUIT ADAPTER. ROUTE 1" CONDUIT (FOR AUXILIARY CABLING) TO NEAREST WALL, RISE TO ABOVE CEILING AND TERMINATE WITH SMOOTH BUSHING, FURNISH AND INSTALL J-HOOKS (3FT. ON CENTER) TO NEAREST CABLE TRAY/SLEEVE/AUXILIARY BACKBOARD. (ACTIVATION COVER FINISH AS SELECTED BY ARCHITECT). FURNISH AND INSTALL 2 EACH CAT 6 CABLES FROM FLOOR BOX TO NEAREST AUXILIARY BACKBOARD AND TERMINATE PER SPECIFICATIONS.

• (FLOOR OUTLET - (RECESSED ACTIVATION POKE THRU - POWER, COMMUNICATIONS, A/V) a. WREMOLD# 10ATC COMPLETE WITH THE FOLLOWING: 1) COVER (COVER TYPE AND FINISH AS SELECTED BY ARCHITECT) 2) 2 EACH DUPLEX RECEPTACLES, EACH RECEPTACLE TO BE HALF-SWITCHED 3)1 EACH COMMUNICATION PLATE WITH 3 EACH CAT6 PORTS (2 DATA AND 1 A/V) 4)1 EACH HDMI (QUIKTRON# 2212-42422-001) 6) FACEPLATES, INSERTS, BRACKETS AND BEZELS AS REQUIRED. D. FURNISH AND INSTALL THE FOLLOWING CONDUITS AND CABLES TO NEAREST WALL AND RISE TO ACCESSIBLE CEILING. 1) %"C (POWER) TO CIRCUIT AS INDICATED ON DRAWINGS AND CONNECT AS REQUIRED. 2)1°C (DATA) WITH CAT6 CABLES TO NEAREST BACKBOARD AND CONNECT AS REQUIRED. 3) 1°C (PODIÚM A/V) WITH CAT6 CABLE TO SOUND SYSTEM 4)1"C (A/V - HDMI) WITH DIGITAL HIGH-SPEED RUNNER CABLE (QUIKTRON# 2212-42408-100 LENGTH AS PERMISSIBLE) TO DISPLAY (CDP) AND CONNECT AS REQUIRED.

5) 1 °C (A/V - MULTIMEDIA) WITH PC RUNNER CABLE (QUIKTRON# 2212-42143-150 - REDUCE

PERMISSIBLE) TO DISPLAY (CDP) AND CONNECT AS REQUIRED. ▶ (●) FLOOR OUTLET — (RECESSED ACTIVATION FLOOR BOX — POWER, COMMUNICATIONS, A/V) a. WREMOLD# RFB11 COMPLETE WITH THE FOLLOWING: 1) COVER (COVER TYPE AND FINISH AS SELECTED BY ARCHITECT) 2) 2 EACH DUPLEX RECEPTACLES, EACH RECEPTACLE TO BE HALF-SWITCHED 3)1 EACH COMMUNICATION PLATE WITH 3 EACH CAT6 PORTS (2 DATA AND 1 A/V) 4) 1 EACH HDMI (QUIKTRON# 2212-42422-001) 5)1 EACH MULTIMEDIA (QUIKTRON# 2212-0854-001) 6) FACEPLATES, INSERTS, BRACKETS AND BEZELS AS REQUIRED.

5. FURNISH AND INSTALL THE FOLLOWING CONDUITS AND CABLES TO NEAREST WALL AND RISE TO ACCESSIBLE CEILING. 1) %"C (POWER) TO CIRCUIT AS INDICATED ON DRAWINGS AND CONNECT AS REQUIRED. 2)1 C (DATA) WITH CAT6 CABLES TO NEAREST BACKBOARD AND CONNECT AS REQUIRED. 3)1°C (PODIUM A/V) WITH CAT6 CABLE TO SOUND SYSTEM 4)1°C (A/V - HDMI) WITH DIGITAL HIGH-SPEED RUNNER CABLE (QUIKTRON# 2212-42408-100

LENGTH AS PERMISSIBLE) TO DISPLAY (\triangleleft LCDP) AND CONNECT AS REQUIRED. 5)1°C (A/V - MULTIMEDIA) WITH PC RUNNER CABLE (QUIKTRON# 2212-42143-150 - REDUCE PERMISSIBLE) TO DISPLAY (LCDP) AND CONNECT AS REQUIRED.

AUXILIARY LEGEND

- ▲ DATA DROP SEE AUXILIARY OUTLET DETAIL 16" ABOVE FINISHED FLOOR
- DATA DROP SEE AUXILIARY OUTLET DETAIL ABOVE COUNTER OR OTHER DESIGNATED HEIGHT (HEIGHT TO BE NOTED AT DEVICE)
- WAP WAP DROP SEE AUXILIARY OUTLET DETAIL
- ▲ TV DROP SEE AUXILIARY OUTLET DETAIL

4 CONDUIT SLEEVE FOR LOW-VOLTAGE CABLING. FIRST NUMBER INDICATES SLEEVE QUANTITY, SECOND

- NUMBER INDICATES SLEEVE SIZE. ALL FIRE RATED PENETRATIONS SHOWN WITH 2" OR 4" SLEEVES SHALL INCLUDE WIREMOLD FLAMESTOPPER. CAULK, WOOL AND PUTTY WILL NOT BE ACCEPTABLE FIRE RATED SEALS FOR 2" AND 4" SLEEVES
- -CT- WIRE BASKET CABLE TRAY SHALL BE CABLOFIL# CF150/ 200 8"W, 6"D AND SHALL BE CENTER HUNG. INCLUDE ALL HARDWARE AS REQUIRED FOR MOUNTING.
- SECURITY
- CARD READER SEE SPECIFICATIONS AND DETAILS. CONNECT TO ACCESS CONTROL SYSTEM AS REQUIRED

- DOOR MONITOR/ DOOR POSITION SWITCH SEE SPECIFICATIONS AND DETAILS. CONNECT TO ACCESS CONTROL SYSTEM AS REQUIRED
- ←(CC) VIDEO SURVEILLANCE CAMERA SEE DETAILS
- ←(CW) VIDEO SURVEILLANCE CAMERA SEE DETAILS

A/V SYSTEMS LEGEND

- LOW-VOLTAGE RAISE LOWER STOP SWITCH FOR MOTORIZED PROJECTOR SCREEN CONTROL. MOUNT SWITCH IN FLUSH
- BOX AND CONNECT TO MOTORIZED SCREEN AS REQUIRED SEE PLANS AND DETAILS AUDIO VIDEO INPUT LOCATION. SEE PLANS, DETAILS AND SPECIFICATIONS. PROVIDE TWO (2) EACH 1"C TO ABOVE ACCESSIBLE CEILING WITH CABLING AS REQUIRED FOR AUDIO VIDEO (4K) CONNECTIONS TO AV SWITCHER. AV INPUT LOCATION TO BE SELECTABLE FROM WALL TOUCH PANEL. AV OUTPUT LOCATION (PROJECTOR AND/ OR WALL DISPLAY) TO SELECTABLE FROM WALL TOUCH PANEL.
- ITP INTERACTIVE TOUCH PANEL MOUNTED ON WALL. SEE PLANS, DETAILS AND SPECIFICATIONS
- AVR AUDIO/ VIDEO SYSTEM RACK. SEE PLANS, DETAILS AND SPECIFICATIONS
- AV SYSTEM VACANCY SENSOR. SEE PLANS, DETAILS AND SPECIFICATIONS
- ROOM CONTROLLER AND SCALER MOUNTED ABOVE CEILING NEAR PROJECTOR. SEE PLANS, DETAILS AND
- CEILING MOUNT PROJECTOR WITH CEILING PLATE, ARM AND PROJECTOR MOUNT, PROJECTOR SHALL BE PANASONIC# PT-RZ770WU. SEE PLANS, DETAILS AND SPECIFICATIONS. OPTIMUM THROW DISTANCE IS 23'-1", THROW RANGE IS 11'-4" TO 69'-7". SEE ARCHITECTURAL PLAN FOR SCREEN MOUNTING LOCATION. PROJECTOR SHALL BE MOUNTED AS NEAR TO THE OPTIMAL THROW RANGE, FROM THE SCREEN, AS POSSIBLE. PROVIDE TWO (2) EACH 1"C TO ABOVE ACCESSIBLE CEILING WITH CABLING AS REQUIRED FOR AUDIO VIDEO (4K) CONNECTIONS TO AV SWITCHER. AV INPUT LOCATION TO BE SELECTABLE FROM WALL TOUCH PANEL. AV OUTPUT LOCATION (PROJECTOR AND/ OR WALL DISPLAY) TO SELECTABLE FROM WALL TOUCH PANEL.
- MOTORIZED PROJECTION SCREEN. SEE PLANS, DETAILS AND SPECIFICATIONS. SCREEN SHALL BE DA-LITE# 29881 (OR PRE-APPROVED EQUAL)
- CR (S) CEILING MOUNTED SPEAKER. SEE PLANS, DETAILS AND SPECIFICATIONS
- BF (M) CEILING MOUNTED MICROPHONE. SEE PLANS, DETAILS AND SPECIFICATIONS
- WALL MOUNTED LECTURE CAMERA ON FLUSH BOX. SEE ARCHITECTURAL ELEVATIONS FOR MOUNTING HEIGHT. SEE PLANS, DETAILS AND SPECIFICATIONS CONFERENCE WALL DISPLAY. SEE PLANS, DETAILS AND SPECIFICATIONS. PROVIDE TWO (2) EACH 1"C TO ABOVE ACCESSIBLE CEILING WITH CABLING AS REQUIRED FOR AUDIO VIDEO (4K) CONNECTIONS TO AV SWITCHER. AV INPUT LOCATION TO BE SELECTABLE FROM WALL TOUCH PANEL. AV OUTPUT LOCATION (PROJECTOR AND/ OR WALL


DISPLAY) TO SELECTABLE FROM WALL TOUCH PANEL. HEIGHT AS NOTED ON ARCHITECTURAL ELEVATIONS.

CONFERENCE WALL DISPLAY. SEE PLANS, DETAILS AND SPECIFICATIONS. PROVIDE TWO (2) EACH 1"C TO ABOVE ACCESSIBLE CEILING WITH CABLING AS REQUIRED FOR AUDIO VIDEO (4K) CONNECTIONS TO AV SWITCHER. AV INPUT OCATION TO BE SELECTABLE FROM WALL TOUCH PANEL. HEIGHT AS NÓTED ON ARCHITECTURAL ELEVATIONS.

COORDINATE WITH GENERAL CONTRACTOR FOR ALL REQUIRED BLOCKING IN WALL. SEE DETAIL: FLOOR BOX TYPE

- COORDINATE WITH GENERAL CONTRACTOR FOR ALL REQUIRED BLOCKING IN WALL. SEE DETAIL: FLOOR BOX TYPE "PRA" AND "FRA" (S) CEILING MOUNTED SPEAKER. SEE PLANS, DETAILS AND SPECIFICATIONS
- W CEILING MOUNTED SUB-WOOFER. SEE PLANS, DETAILS AND SPECIFICATIONS

EE Group Inc. TEL: (256)413-7717 FAX: (256)413-7789 WEB: WWW.EEGRPINC.COM lot Date: Apr 02, 2021 8:54:00 am

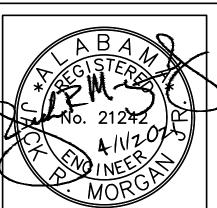

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APPROVED OWNERS SIGNAGE SCHEME) FOR EACH F.A. SYSTEM DEVICE SUCH THAT ALARMS AND DEVICE LOCATIONS MATCH BUILDING SIGNAGE. 2. FIRE ALARM SUB-CONTRACTOR TO FURNISH POINT TO POINT WIRING DIAGRAM BY THE FIRE ALARM MANUFACTURER WITH FIRE ALARM SYSTEM SUBMITTALS. POINT TO POINT WIRING DIAGRAMS SHALL INCLUDE ALL WIRING INFORMATION AND CONDUIT SIZES. REQUIRED WIRING DIAGRAMS SHALL BE FURNISHED WITH THE ELECTRICAL SUBMITTAL PACKAGE, SUBMITTAL PACKAGES WITHOUT THESE DRAWINGS AND THE REQUIRED

3. ELECTRICAL CONTRACTOR SHALL COORDINATE ALL WIRING REQUIREMENTS WITH THE FIRE ALARM SYSTEM SUBCONTRACTOR PRIOR TO BIDDING AND/OR ROUGHING. FURNISH AND INSTALL ALL REQUIRED 120V. CIRCUITS FOR AMPLIFIERS, FIELD CHARGING PANELS, RELAY PANELS, ETC...

1. FIRE ALARM CONTRACTOR TO INCLUDE IN BID PRICE REQUIRED PROGRAMMING SERVICES SUCH THAT THE FINAL ROOM NUMBERS (PER THE

FIRE ALARM CONTROL PANEL - EDWARDS MODEL VS2 SERIES INTELLIGENT ADDRESSABLE ANALOG FIRE DETECTION CONTROL PANEL WITH

PROVIDE FACTORY INSTALLED BATTERY BACKUP AND FACTORY INSTALLED SURGE SUPPRESSION DEVICE IN FACP.

BB1 TO FIRE ALARM CONTROL PANEL. CAT5E SHALL BE ROUTED IN 3/4" EMT CONDUIT FROM POINT "A" TO

REMOTE FIRE ALARM NAC PANEL - EDWARDS MODEL APS10A SURFACE MOUNTED AT LOCATIONS SHOWN IN FACTORY BOX. SEE PLANS

MANUAL PULL STATION - EDWARDS MODEL E85001-0279 W/ FLUSH MOUNTED BACKBOX (4" SQUARE BOX WITH SINGLE GANG RAISED

FIRE ALARM SPEAKER STROBE - EDWARDS MODEL GCF-52VM - CEILING MOUNTED ON FLUSH 4" SQUARE BOX WITH 1-1/2" EXTENSION

WEATHERPROOF FIRE ALARM HORN STROBE - EDWARDS MODEL 4WGWF-SVMC - WALL MOUNTED ON FLUSH 4" SQUARE BOX @ +144

FIRE ALARM STROBE - EDWARDS MODEL GCF-VM - CEILING MOUNTED ON FLUSH 4" SQUARE BOX WITH 1-1/2" EXTENSION RING

DUCT DETECTOR (S=SUPPLY AIR - R= RETURN AIR) - EDWARDS MODEL E85001-0584 W/ SAMPLING TUBE & RELAY FURNISHED BY

FLOW SWITCH MONITOR MODULE - EDWARDS MODEL GSA-CT1. FLOW SWITCH FURNISHED AND INSTALLED BY OTHERS, MODULE FURNISHED AND INSTALLED BY FIRE ALARM CONTRACTOR. CONNECT TO FACP AS A SEPARATE ZONE.

TAMPER SWITCH MONITOR MODULE - EDWARDS MODEL GSA-CT1 TAMPER SWITCH FURNISHED AND INSTALLED BY OTHERS, MODULE

REMOTE TEST STATION (KEY OPERATED) - KEY BOX TYPE, FLUSH MOUNTED, HEIGHT CONDUIT AND WIRE TO DUCT DETECTOR AS

CONTRACTOR SHALL PROVIDE COMPLETE, INDEPENDENT 2EA. CAT5E TELEPHONE LINE FROM AUXILIARY BACKBOARD/ MDF:

4. ALL FIRE ALARM CABLING SHALL BE INSTALLED CONCEALED IN CONDUIT, 3/4" MINIMUM (NO EXCEPTIONS). ALL FIRE ALARM CONDUITS SHALL BE RED TRUE COLOR EMT AS MANUFACTURED BY ALLIED TUBE AND CONDUIT.

5. FIRE ALARM SYSTEM CONTRACTOR SHALL FURNISH AND INSTALL REMOTE TEST STATION(S) FOR ALL DUCT MOUNTED SMOKE DETECTORS. THESE STATIONS SHALL BE LABELED WITH THE DEVICE NUMBER AND THE UNIT NUMBER. THE REMOTE TEST STATION(S) SHALL BE LOCATED IN AN ACCESSIBLE LOCATION.

6. THE ELECTRICAL CONTRACTOR SHALL COORDINATE LOCATIONS FOR ALL FIRE PROTECTION SYSTEM VALVES WITH THE FINAL FIRE PROTECTION SYSTEM PLANS PRIOR TO BIDDING AND/OR ROUGHING. AT EACH CONTROL VALVE, THE CONTRACTOR SHALL PROVIDE FIRE ALARM SYSTEM CONNECTIONS TO THE FLOW AND TAMPER SWITCHES (FURNISHED AND INSTALLED BY OTHERS).

7. DUCT MOUNTED SMOKE DETECTORS FURNISHED BY THE ELECTRICAL CONTRACTOR. AND INSTALLED BY THE MECHANICAL CONTRACTOR LOCATIONS SHOWN ARE FOR REFERENCE ONLY, COORDINATE EXACT LOCATION WITH THE MECHANICAL PLANS AND FINAL CONNECTIONS BY FIRE ALARM CONTRACTOR. PROVIDE ALL EQUIPMENT REQUIRED FOR SHUTDOWN OF THE UNITS BY THE FIRE ALARM CONTROL PANEL AS REQUIRED. 8. CONTRACTOR SHALL PROVIDE WITH THE FIRE ALARM SUBMITTAL PACKAGE THE FOLLOWING INFORMATION PER IBC 2015:

COPY OF STATE OF ALABAMA FIRE ALARM CONTRACTOR LICENSE/PERMIT LOCATION OF ALARM INITIATING DEVICES CONDUCTOR TYPES AND SIZES AND TERMINATING EQUIPMENT MODEL NUMBERS AND LISTING INFORMATION FOR EQUIPMENT DEVICES AND MATERIALS

9. THE NEW FIRE ALARM SYSTEMS WILL COMPLY WITH THE REQUIREMENTS OF THE FOLLOWING CODES: INTERNATIONAL BUILDING CODE 2015 INTERNATIONAL FIRE CODE 2015 NFPA 72 2013

REQUIREMENTS OF THE ACT AND HOLDS A PERMIT ISSUED BY THE STATE FIRE MARSHALL.

10. THE CERTIFIED FIRE ALARM ACT REQUIRES THAT EVERY BUSINESS WHO INSTALLS FIRE ALARM SYSTEMS IN COMMERCIAL OCCUPANCIES MUST BE LICENSED AS A CERTIFIED FIRE ALARM CONTRACTOR. THE CONTRACTOR MUST HAVE A NICET LEVEL III TECHNICIAN IN A POSITION OF RESPONSIBILITY, AND THE LICENSE WILL BE ISSUED IN THE NAME OF THE CERTIFICATE HOLDER AND THE CONTRACTOR. THE CERTIFIED FIRE ALARM ACT ALSO REQUIRES THAT TECHNICIANS WORKING FOR THE CERTIFIED CONTRACTOR MUST HOLD A CURRENT NICET LEVEL II, OR EQUIVALENT. CERTIFICATION. CONTRACTORS TO SHOW EVIDENCE WITH SUBMITTAL PACKAGE THAT HE/SHE MEETS THE CERTIFICATION

11. THE FIRE DETECTION AND ALARM SYSTEM CONTROLS CONTRACTOR SHALL HOLD A PERMIT FROM THE ALABAMA STATE FIRE MARSHAL. THE FIRE ALARM SYSTEM CONTRACTOR SHALL PROVIDE A COPY OF THE STATE FIRE MARSHAL'S PERMIT TO THE GENERAL CONTRACTOR SO THAT THE ENGINEER MAY REVIEW THE CONTRACTOR'S QUALIFICATIONS PRIOR TO ANY WORK TAKING PLACE. SEE SPECIFICATIONS SECTION 266520A.

APPENDIX FOR COPY OF STATE REQUIREMENTS FOR FIRE ALARM CONTRACTORS DESIRING TO BID THIS PROJECT.

SPECIAL FIRE ALARM NOTE:

ALL REQUIREMENTS OF THE AUTHORITY HAVING JURISDICTION

NEW FIRE ALARM SYSTEM (FIRE ALARM CONTROL PANEL, FIRE ALARM DEVICES, FIRE ALARM CABLING, FIRE ALARM SYSTEM SET-UP AND PROGRAMMING) TO BE FURNISHED AND INSTALLED UNDER BASE BID.

AREA OF RESCUE ASSISTANCE

SYSTEM LEGEND

FIRE ALARM LEGEND

STAND-BY BATTERY SURFACE MOUNTED AT 5'-0" TO CENTERLINE

FURNISH AND INSTALL INTEGRAL VOICE EVACUATION

MICROPHONE ADJACENT TO ANNUNCIATOR IN SAME FLUSH MOUNTED BOX.

COVER) MOUNTED @ + 44" A.F.F. TO BOTTOM.

REQUIRED. PROVIDE FINAL CONNECTIONS AS REQUIRED

INTERPOSING RELAY FOR USE WITH CONTROL ZAM, 20 AMP CONTACTS

F FIRE ALARM CONDUIT & WIRE - SEE FIRE SYSTEM NOTES.

FIRE ALARM SYSTEM NOTES

POINT "B" AND TERMINATED AS REQUIRED BY FIRE ALARM TECHNICIAN.

FURNISH AND INSTALL POINT ID CELLULAR DIALER FOR PRIMARY AND BACK-UP AT FACP.

SMOKE DETECTOR - EDWARDS MODEL E85001-0651 - WITH BASE/CEILING MOUNTED ON FLUSH 4" SQUARE BOX

DD-R FIRE ALARM CONTRACTOR, INSTALLED IN DUCT BY MECHANICAL, FINAL CONNECTIONS BY FIRE ALARM CONTRACTOR.

BOX HEAT DETECTOR - EDWARDS MODEL E85001-0620 - WITH BASE/CEILING MOUNTED ON FLUSH 4" SQUARE BOX

FURNISHED AND INSTALLED BY FIRE ALARM CONTRACTOR. CONNECT TO FACP AS REQUIRED.

WG WIRE GUARD W/ TAMPER PROOF SCREWS - REQUIRED IN GYM, AUXILIARY GYM, AND WHERE SHOWN


 $oxedsymbol{|Z|_{\mathsf{M}}}$ zam — zone addressable module, monitor (input to fire alarm panel from a device or system)

ZAM - ZONE ADDRESSABLE MODULE, CONTROL (OUTPUT FROM FIRE ALARM PANEL TO A DEVICE OR SYSTEM)

REMOTE FIRE ALARM ANNUNCIATOR PANEL - EDWARDS MODEL K-RLCD-C IN FLUSH MOUNTED SERIES BOX. PROVIDE REMOTE

FURNISH AND INSTALL INTEGRAL WEB SERVER ACCESS CARD.

- RAM AREA OF RESCUE ASSISTANCE MAIN CONTROL PANEL WITH POWER SUPPLY (+48" A.F.F. TO BOTTOM). SEE AREA OF RESCUE ASSISTANCE BLOCK DIAGRAM.
- RAR AREA OF RESCUE ASSISTANCE REMOTE CONTROL PANEL WITH POWER SUPPLY. SEE AREA OF RESCUE ASSISTANCE BLOCK DIAGRAM.
- RAC AREA OF RESCUE ASSISTANCE CALL STATION (+36" A.F.F. TO BOTTOM). SEE AREA OF RESCUE ASSISTANCE BLOCK DIAGRAM.
- RAP AREA OF RESCUE ASSISTANCE POWER SUPPLY. SEE AREA OF RESCUE ASSISTANCE BLOCK DIAGRAM.

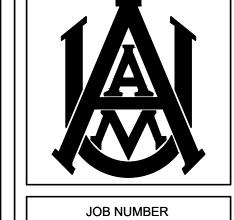

JRM / JRM / 1/25/2021 DRAWN - CHECKED - DATE

REVISIONS Description ADDENDUM#2 2/12/21 ADDENDUM#3 3/19/21 ADDENDUM#6 4/1/21


SHEET TITLE **ELECTRICAL**

LEGEND

SHEET NUMBER


E-1.0



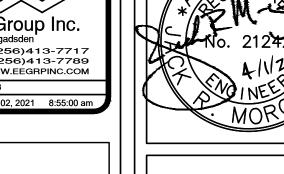

SPECIAL NOTE:

1. ADDITIONAL METERING WAS NOT INCLUDED FOR ELECTRICAL ENERGY MONITORING BASED ON EXCEPTION TO ASHRAE 90.1 (2013) 8.4.3.1 AND 2 AS BUILDING IS LESS THAN 25,000 SQUARE FEET AT 15,916 SQUARE FEET TOTAL

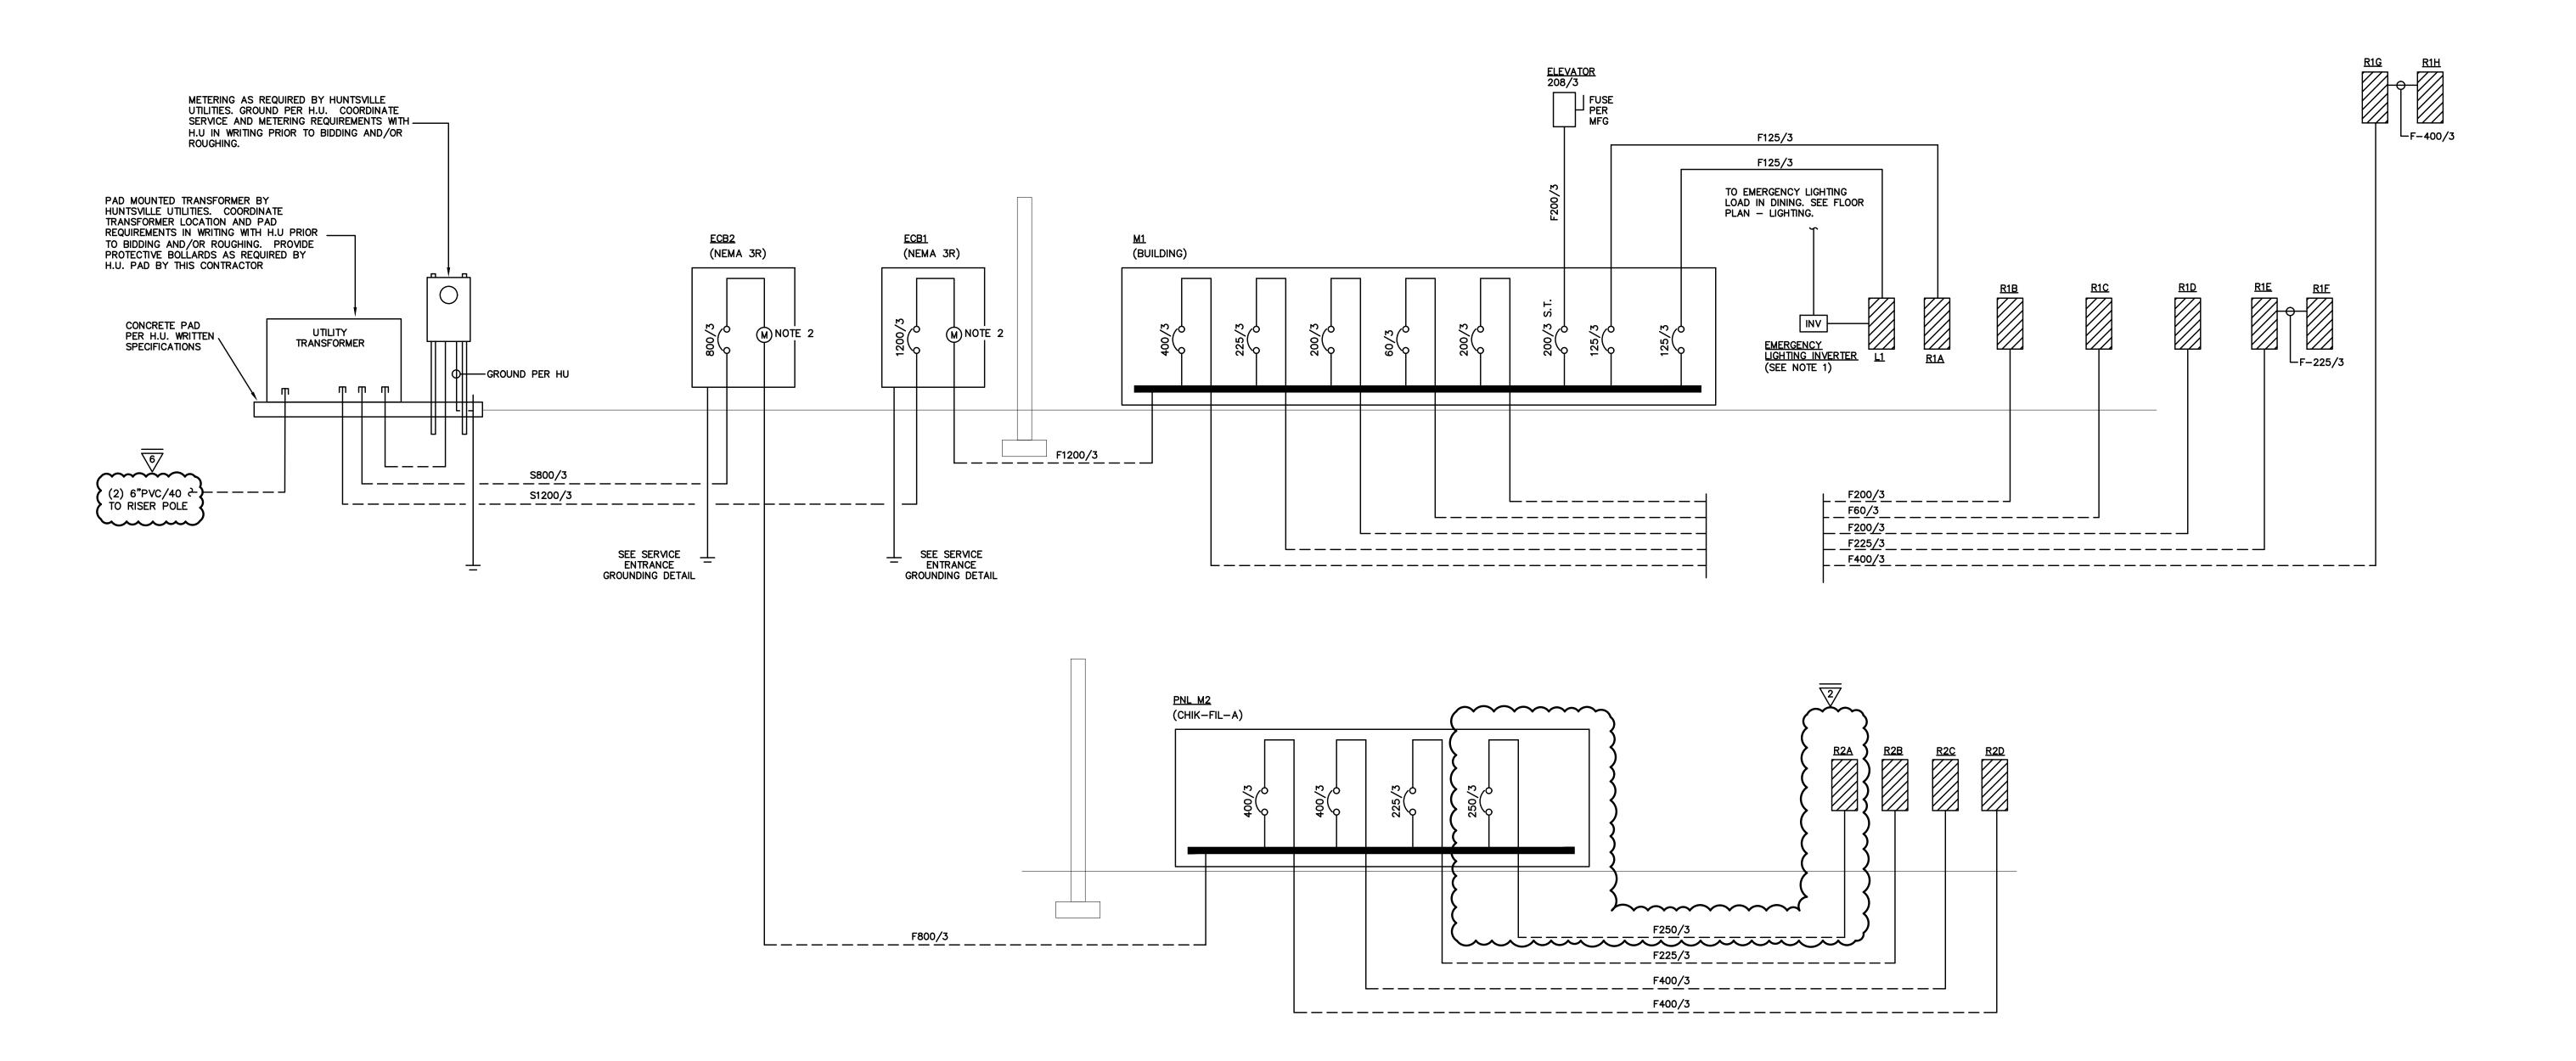

SINGLE LINE DIAGRAM

NOT TO SCALE

SINGLE LINE DIAGRAM NOTES:

 FURNISH AND INSTALL EMERGENCY LIGHTING INVERTER (LVS# CEPS-A-500-120-1) COMPLETE WITH UL924 CONTROL FOR EMERGENCY LIGHTING. INVERTER SHALL BE IN ELECTRICAL ROOM ADJACENT TO PANEL. INSTALL, TEST AND COMMISSION PER MANUFACTERERS RECOMMENDATIONS.

2. FURNISH AND INSTALL 1 EACH CAT6 CABLE IN 1"C FROM DIGITAL METER LOCATION TO IT 105 AND CONNECT TO LAN AS REQUIRED FOR METER MONITORING

CONDUCTOR SCHEDULE

250/3	4#250MCM, 1#4G, 3"C
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1200/3	4 RUNS (4#350 MCM, 1#3/0, 3-1/2"C)
800/3	2 RUNS (4#600 MCM, 1#1/0G, 4"C)
400/3	4#600 MCM, 1#3G, 4"C
-225/3	4#4/0, 1#4G, 3"C
200/3	4#3/0, 1#6G, 2-1/2"C
125/3	4#1, 1#6G, 2"C
100/3	4#3, 1#8G, 1-1/4"C
60/3	4#6, 1#10G, 1-1/4"C
51200/3	4 RUNS (4#350 MCM, 3"C)
8800/3	2 RUNS (4#600 MCM, 4"C)
EEDER TAG	CONDUCTOR AND CONDUIT

# UL LISTED CONNECTOR MECHANICAL TYPE #3/0 CU (BARE) TYPICAL #1/0 CU (BARE) TYPICAL FUSION WELDS GROUNDING ELECTRODE — 3/4" X 10 FT. COPPER— CLAD GROUND

SERVICE ENTRANCE

EQUIPMENT (TYPICAL)

# SERVICE ENTRANCE GROUNDING

ROD DRIVEN FLUSH W/ GRADE. MIN. SPACING 20FT. (TYPICAL OF 3)

NOT TO SCALE

(TYPICAL)

NOTES

1. BOND METAL PIPING SYSTEMS INCLUDING GAS PIPING TO THE SERVICE EQUIPMENT ENCLOSURE PER NEC 250.104(B), SIZED PER 250.122 BASED ON THE SIZE OF THE CIRCUIT SUPPLYING THE EQUIPMENT.

SHEET TITLE

**ELECTRICAL** 

SINGLE LINE DIAGRAM

JOB NUMBER

JRM / JRM / 1/25/2021

ADDENDUM#2 2/12/21

ADDENDUM#3 3/19/21

ADDENDUM#6 4/1/21

DRAWN - CHECKED - DATE

Description

REVISIONS

E-3.0

SHEET NUMBER

OF