ARCHITECT:

EDT-THA ARCHITECTURE JENNIFER THORINGTON-HINES, AIA 218 RANDOLPH AVENUE SE, SUITE A HUNTSVILLE, ALABAMA 35801 256.883.8496


MECHANICAL & PLUMBING:

TOTAL DESIGN ENGINEERING STEPHEN CLANTON, PE 3408 6TH AVENUE SW HUNTSVILLE, ALABAMA 35805 256.539.8585

ELECTRICAL:

TOTAL DESIGN ENGINEERING ANDREW MINOR, PE 3408 6TH AVENUE SW HUNTSVILLE, ALABAMA 35805 256.539.8585

VICINITY MAP

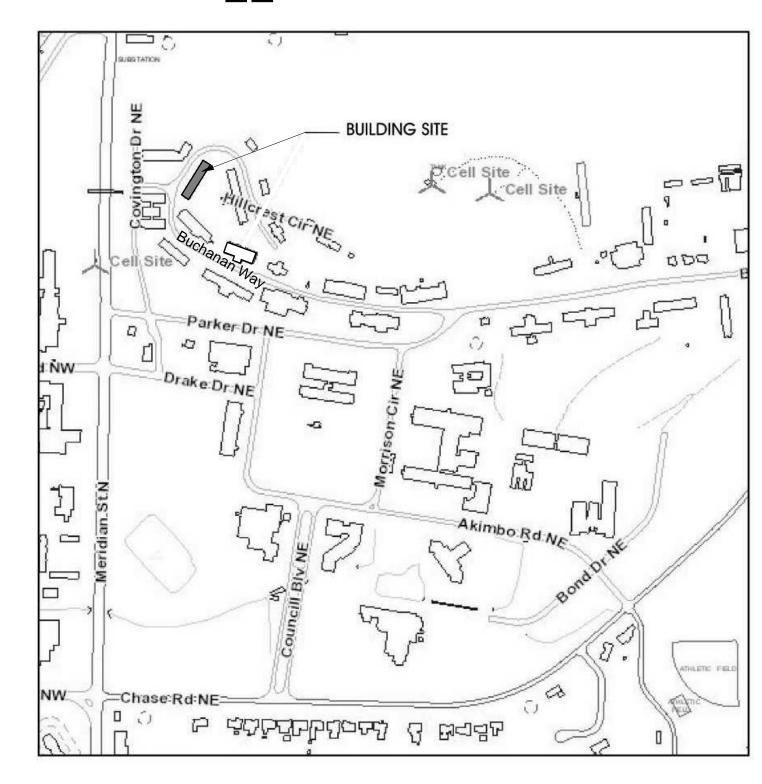

AAMU - COUNCILL HALL

BASEMENT RENOVATIONS

315 BUCHANAN WAY NE **NORMAL, AL 35762**

	INDEX OF DRAWINGS								
Sheet Number	SHEET NAME								
00_GENERA	AL								
G-001	COVER AND INDEX								
G-002	STANDARDS								
AL101	LIFE SAFETY FLOOR PLAN								
05_ARCHITE	ECTURAL								
A-101	BASEMENT FLOOR PLAN								
07_PLUMBIN	NG								
P-101	PLUMBING FLOOR PLAN								
08_MECHAN	IICAL								
M-101	-101 MECHANICAL FLOOR PLAN								
09_ELECTR	ICAL								
E-101	ELECTRICAL FLOOR PLAN								



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LL HALL JOVATIONS

ISSUE DATE

6-14-2023 FOR CONSTRUCTION

DCM (BC) NUMBER 2023472 PROJECT NUMBER 23T-16-00400

REVISIONS

DRAWING TITLE COVER AND **INDEX**

Sign of Quality ARCHITECTURE

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FOR CONSTRUCTION

DCM (BC) NUMBER PROJECT NUMBER 23T-16-00400

Description

DRAWING NO.

1/8" = 1'-0"

FLOOR PLAN

LIFE SAFETY BASEMENT PLAN

SCOPE OF WORK:

WORK CONSISTS OF CONVERTING AN EXISTING 364SF STORAGE ROOM IN THE BASEMENT OF THE COUNCILL HALL DORM BACK INTO A LAUNDRY FACILITY, AND OTHER WORK INDICATED IN THE CONTRACT DOCUMENTS.

APPLICABLE CODES & REGULATIONS:

THE PROJECT SHALL COMPLY WITH CODES, ORDINANCES, OR LAWS HAVING JURISDICTION ON THE PROJECT, WHICH INCLUDE, BUT ARE NOT LIMITED TO:

INTERNATIONAL BUILDING CODE **BUILDING CODE**

2021 EDITION

FIRE PREVENTION CODE INTERNATIONAL FIRE CODE 2021 EDITION

PLUMBING CODE INTERNATIONAL PLUMBING CODE

2021 EDITION

GAS CODE INTERNATIONAL FUEL GAS CODE

2021 EDITION

INTERNATIONAL MECHANICAL CODE MECHANICAL CODE

2021 EDITION

ELECTRICAL CODE NATIONAL ELECTRICAL CODE 2021 EDITION

ACCESSIBILITY CODE 2010 ADA

PROJECT INFORMATION:

BUILDING USAGE: DORMITORY

CONSTRUCTION TYPE: TYPE II-B

OCCUPANCY TYPE: FIT-OUT: BUSINESS, GROUP B

FULLY SPRINKLERED:

NUMBER OF FLOORS:

TOTAL FLOOR AREA: 3,409 SF (BASEMENT)

AREA OF WORK: 364 SF (LAUNDRY ROOM)

OCCUPANT LOAD: 26 (BASEMENT)

RM NO	NAME	OCCUPANCY CLASSIFICATION	RM AREA	O/SF	LOAD	MIN REQD EXITS
'					•	•
101	CLO	(none)	7 SF	300	1	
102	LAUNDRY ROOM	BUSINESS	364 SF	150	3	1
103	COMPUTER LAB	BUSINESS	1652 SF	150	12	1
104	LOBBY	BUSINESS	248 SF	150	2	1
105	ELEVATOR	(none)	48 SF			
106	MECH	ACCESSORY STORAGE AREAS, MECHANICAL EQUIPMENT ROOM	48 SF	300	1	
107	EQUIP	ACCESSORY STORAGE AREAS, MECHANICAL EQUIPMENT ROOM	30 SF	300	1	
108	OFFICE	BUSINESS	72 SF	150	1	1
109	STORAGE	ACCESSORY STORAGE AREAS, MECHANICAL EQUIPMENT ROOM	513 SF	300	2	
110	STORAGE	ACCESSORY STORAGE AREAS, MECHANICAL EQUIPMENT ROOM	135 SF	300	1	
111	ELECTRICAL	ACCESSORY STORAGE AREAS, MECHANICAL EQUIPMENT ROOM	40 SF	300	1	
112	STAIR	(none)	72 SF			
113	MECH EQUIPMENT	ACCESSORY STORAGE AREAS, MECHANICAL EQUIPMENT ROOM	171 SF	300	1	
114	RISER	(none)	8 SF			
'		•	3409 SF		26	,

LIFE SAFETY LEGEND

MAX. TRAVEL DISTANCE


(FT)

(ST)


(LONGEST ROUTE ONLY PER FLOOR SHOWN)

MAX. EXIT CAPACITY MAX EXIT CAPACITY

FIRE EXTINGUISHER CABINET

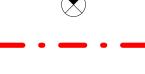

EXIT LIGHT - SEE ELECTRICAL PLANS

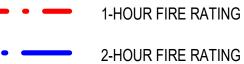

1-HOUR FIRE RATING

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LL HALL JOVATIONS AAMU - COUNCIL BASEMENT RENC

ISSUE DATE 6-14-2023 FOR CONSTRUCTION

DCM (BC) NUMBER 2023472 PROJECT NUMBER

23T-16-00400 REVISIONS


DRAWING TITLE

LIFE SAFETY

FLOOR PLAN

No. Description

DRAWING NO.

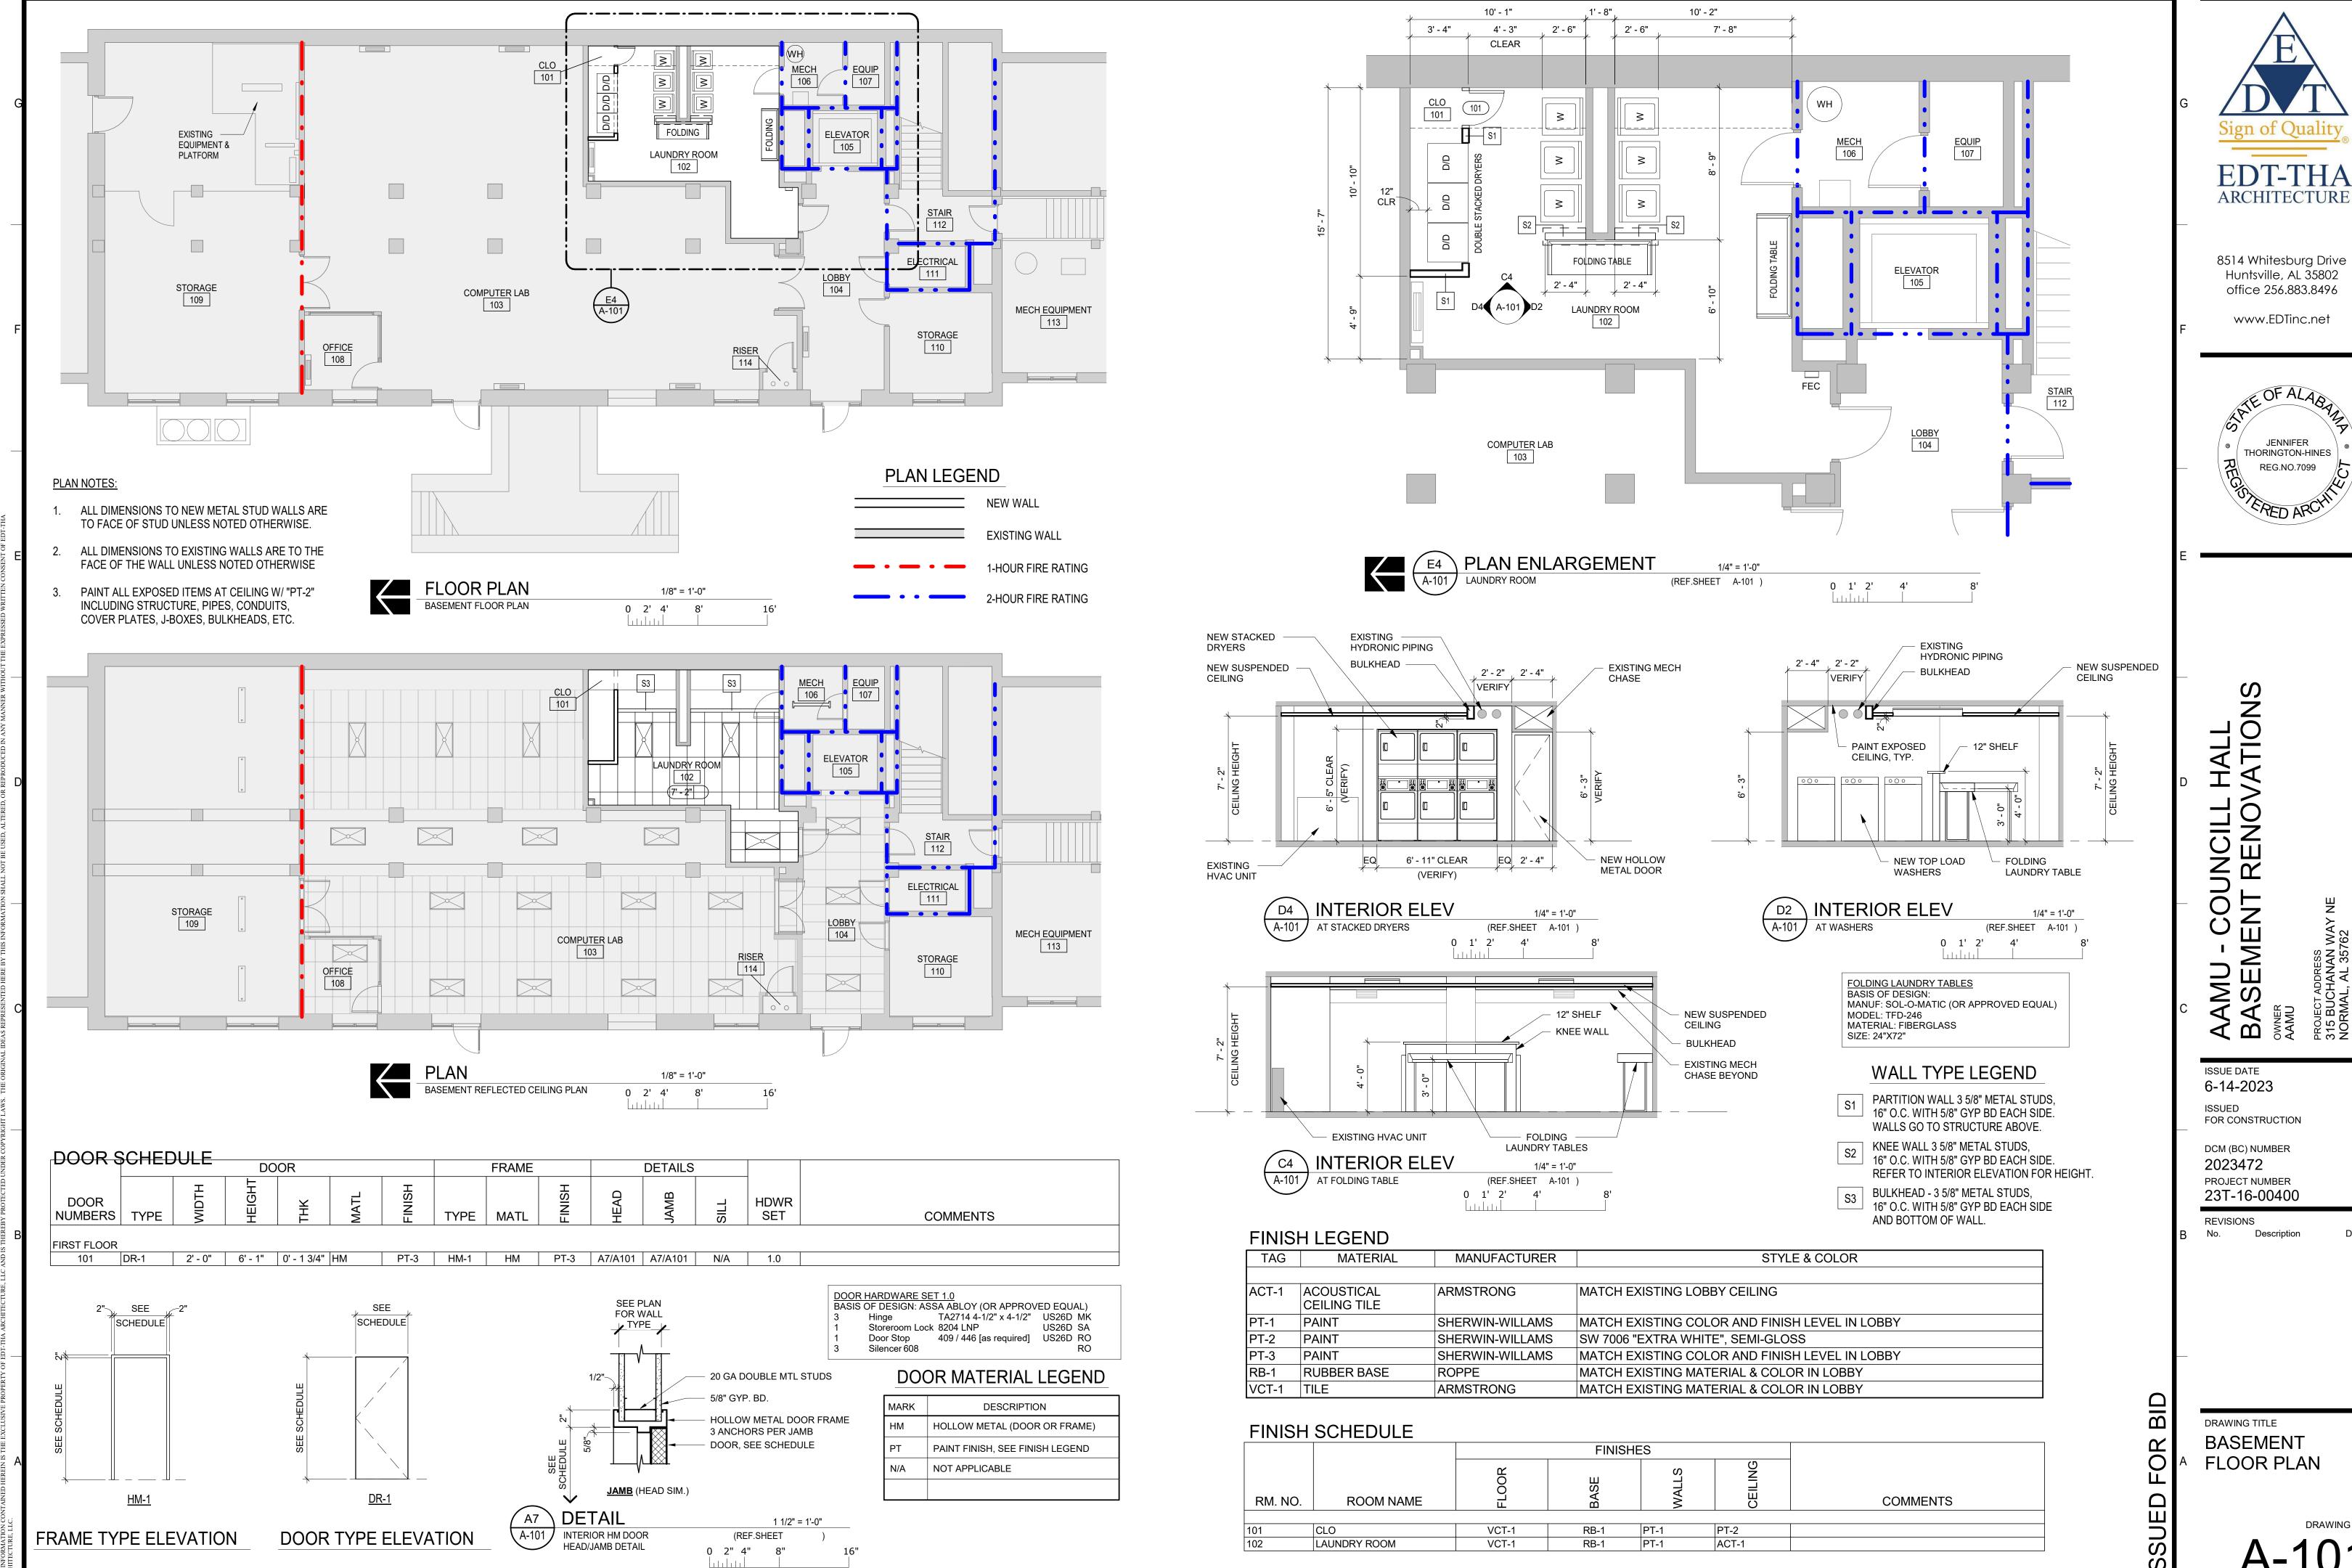



DRAWING NO.

NOT TO SCALE

KEY PLAN

PLUMBING FIXTURE SCHEDULE PIPE SIZE DESCRIPTION WASTE C.W. H.W. WATER HEATER: RHEEM MODEL NO. ELD80, 80 GALLON WITH 2- 5000 WATT ELEMENTS, 208/1/60, FOAM INSULATED, GLASS LINED, OPERATING AND SAFETY CONTROLS, VACUUM BREAKER AND ASME T&P RELIEF _ 1 1/4" 1 1/4" VALVE. INSTALL ON MOUNTING FRAME AS INDICATED ON THE DRAWINGS. INSTALL EXPANSION TANK,


WASHING MACHINE SUPPLY AND DRAIN: GUY GRAY MODEL T200, 20 GAUGE RECESSED STEEL WALL BOX WITH 2"

CENTER DRAIN, WHITE POWDER COAT, HOT AND COLD WATER HOSE CONNECTIONS. PLUMBING CONTRACTOR TO PROVIDE AND INSTALL ALL NECESSARY ADAPTERS. COORDINATE WALL BOX ELEVATION WITH OWNER/VERIFY

	HANDLE KIT (OR EQUAL)
SEAL INSULATION AT HANDLE EXTENSION	—BALL VALVE EQUAL TO WATTS #B6000
PIPE INSULATION TO BE CONTINUOUS OVER VALVE BODY	

HOT & COLD WATER PIPING **SERVICE VALVE DETAIL** NOT TO SCALE


WATTS #XHK EXTENDED

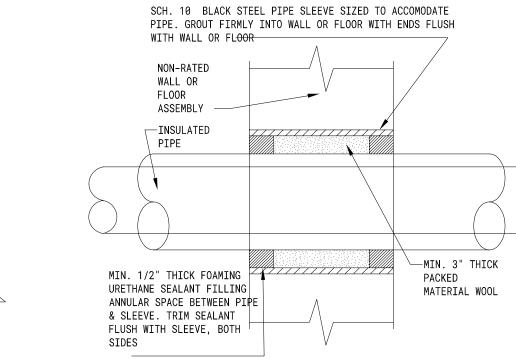


PIPE SLEEVE DETAIL NOT TO SCALE

PLUMBING NOTES ALL PLUMBING VENTS TO BE INSTALLED WITH A MINIMUM OF 10'-0" CLEARANCE FROM ALL OUTSIDE AIR INTAKE SYSTEMS ON MECHANICAL EQUIPMENT. ALL WATER PIPES AT EXTERIOR WALLS SHALL BE INSTALLED ON THE BUILDING SIDE OF THE ALL WATER PIPES SHALL BE INSULATED WITH 1" THICK FIBERGLASS INSULATION WITH VAPOR BARRIER JACKET. 4. EQUAL FIXTURES CAN BE SUBMITTED IN PLACE OF SPECIFIED FIXTURES. 5. PEX PIPING CAN BE INSTALLED IN PLACE OF COPPER PIPING.

- ROUTE WATER HEATER PAN & RELIEF DRAINS TO FLOOR DRAIN IN CLOSET. ALL OF THE PIPING INDICATED ON THE DRAWINGS IS DIAGRAMMATIC ONLY. PIPING MAY BE REQUIRED TO BE SHIFTED, OFFSET AS DETERMINED BY FIELD CONDITIONS. IT IS THE RESPONSIBILITY OF THE CONTRACTOR TO PROVIDE ALL MATERIALS AND LABOR NECESSARY TO INSTALL THE PIPING TO MEET THE DESIGN INTENT ON THE DRAWINGS.
- CERTAIN AREAS WILL REQUIRE EXTENSIVE COORDINATION BETWEEN ALL TRADES. CONTRACTOR(S) SHALL COORDINATE PRIOR/DURING CONSTRUCTION TO ELIMINATE ANY
- CONTRACTOR SHALL NOT PURCHASE OR CONSTRUCT PIPING FROM THE DRAWINGS PRIOR TO VERIFYING PIPING CAN BE INSTALLED IN THE FIELD WITH RESPECT TO FIELD CONDITIONS.

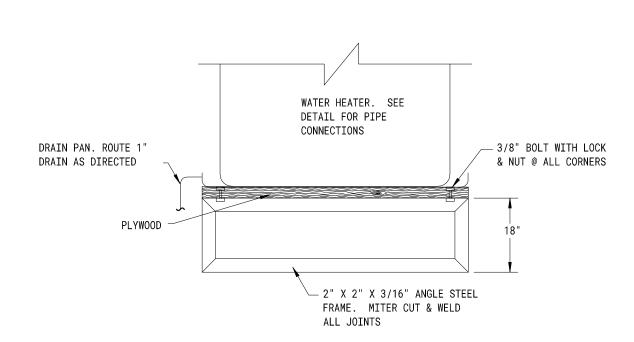


WATER HEATER SUPPORT DETAIL NOT TO SCALE

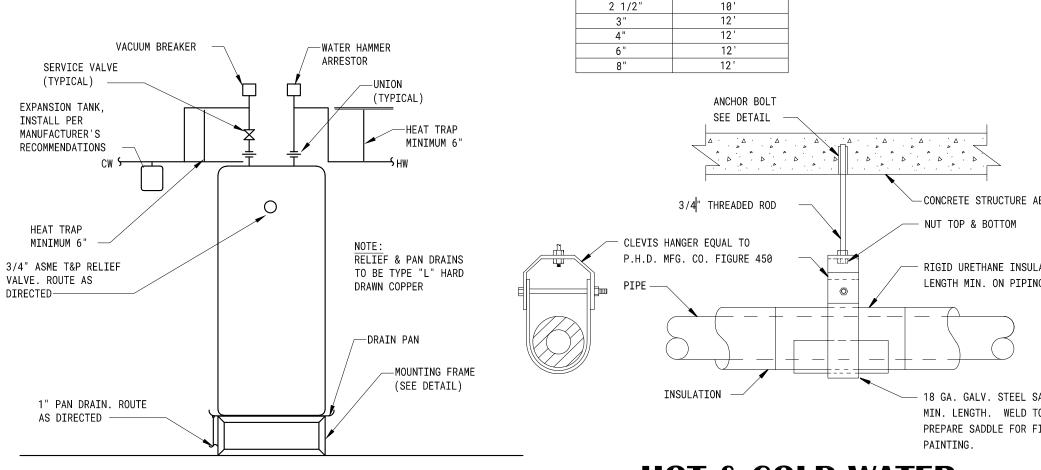


PIPE SUPPORT SCHEDULE


HANGER SPACING


WATER HEATER DETAIL

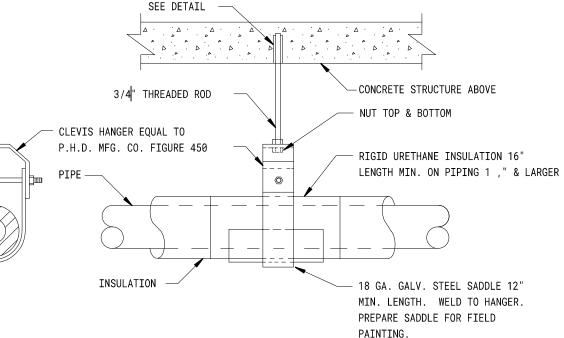

HOT & COLD WATER PIPE HANGER DETAIL NOT TO SCALE

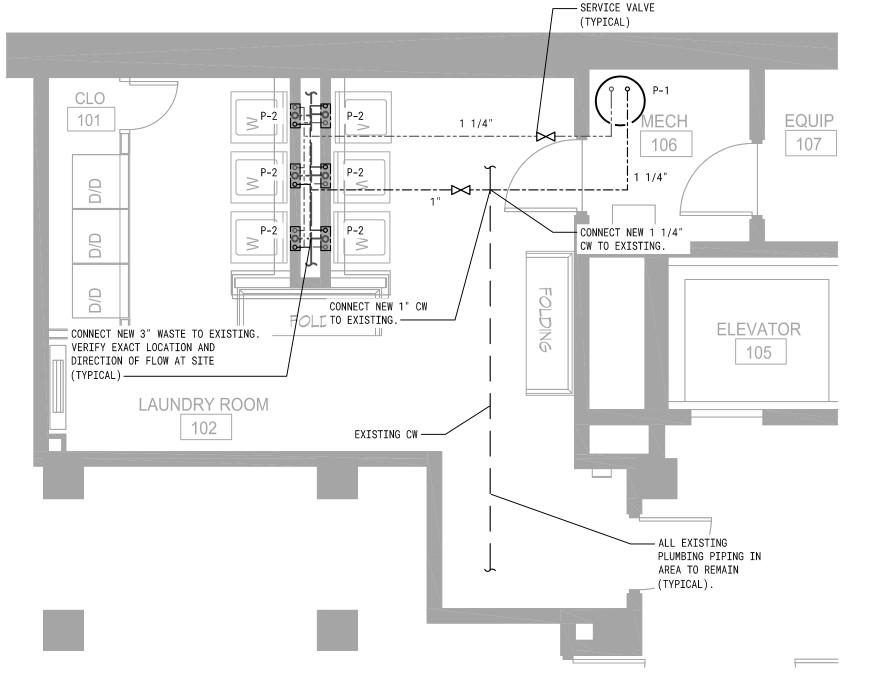


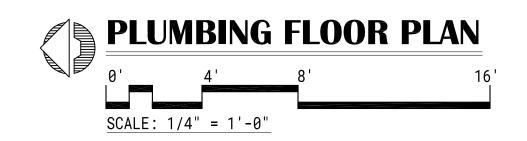

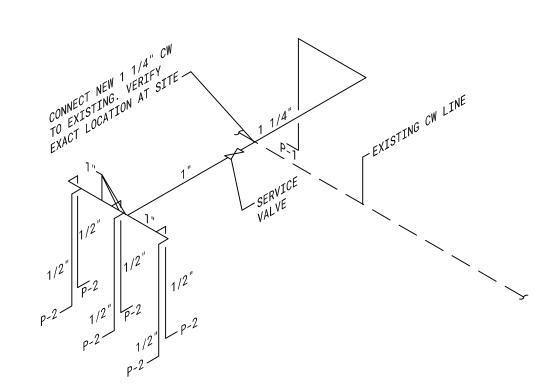


COLD WATER DIAGRAM

NOT TO SCALE

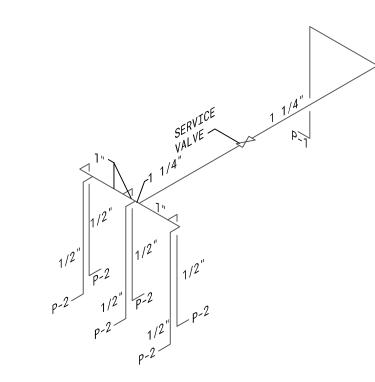


HOT WATER DIAGRAM NOT TO SCALE

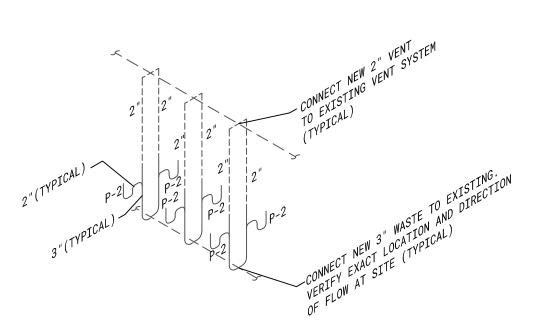

WASTE/VENT DIAGRAM

NOT TO SCALE

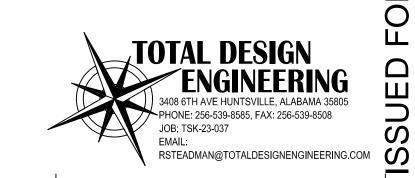

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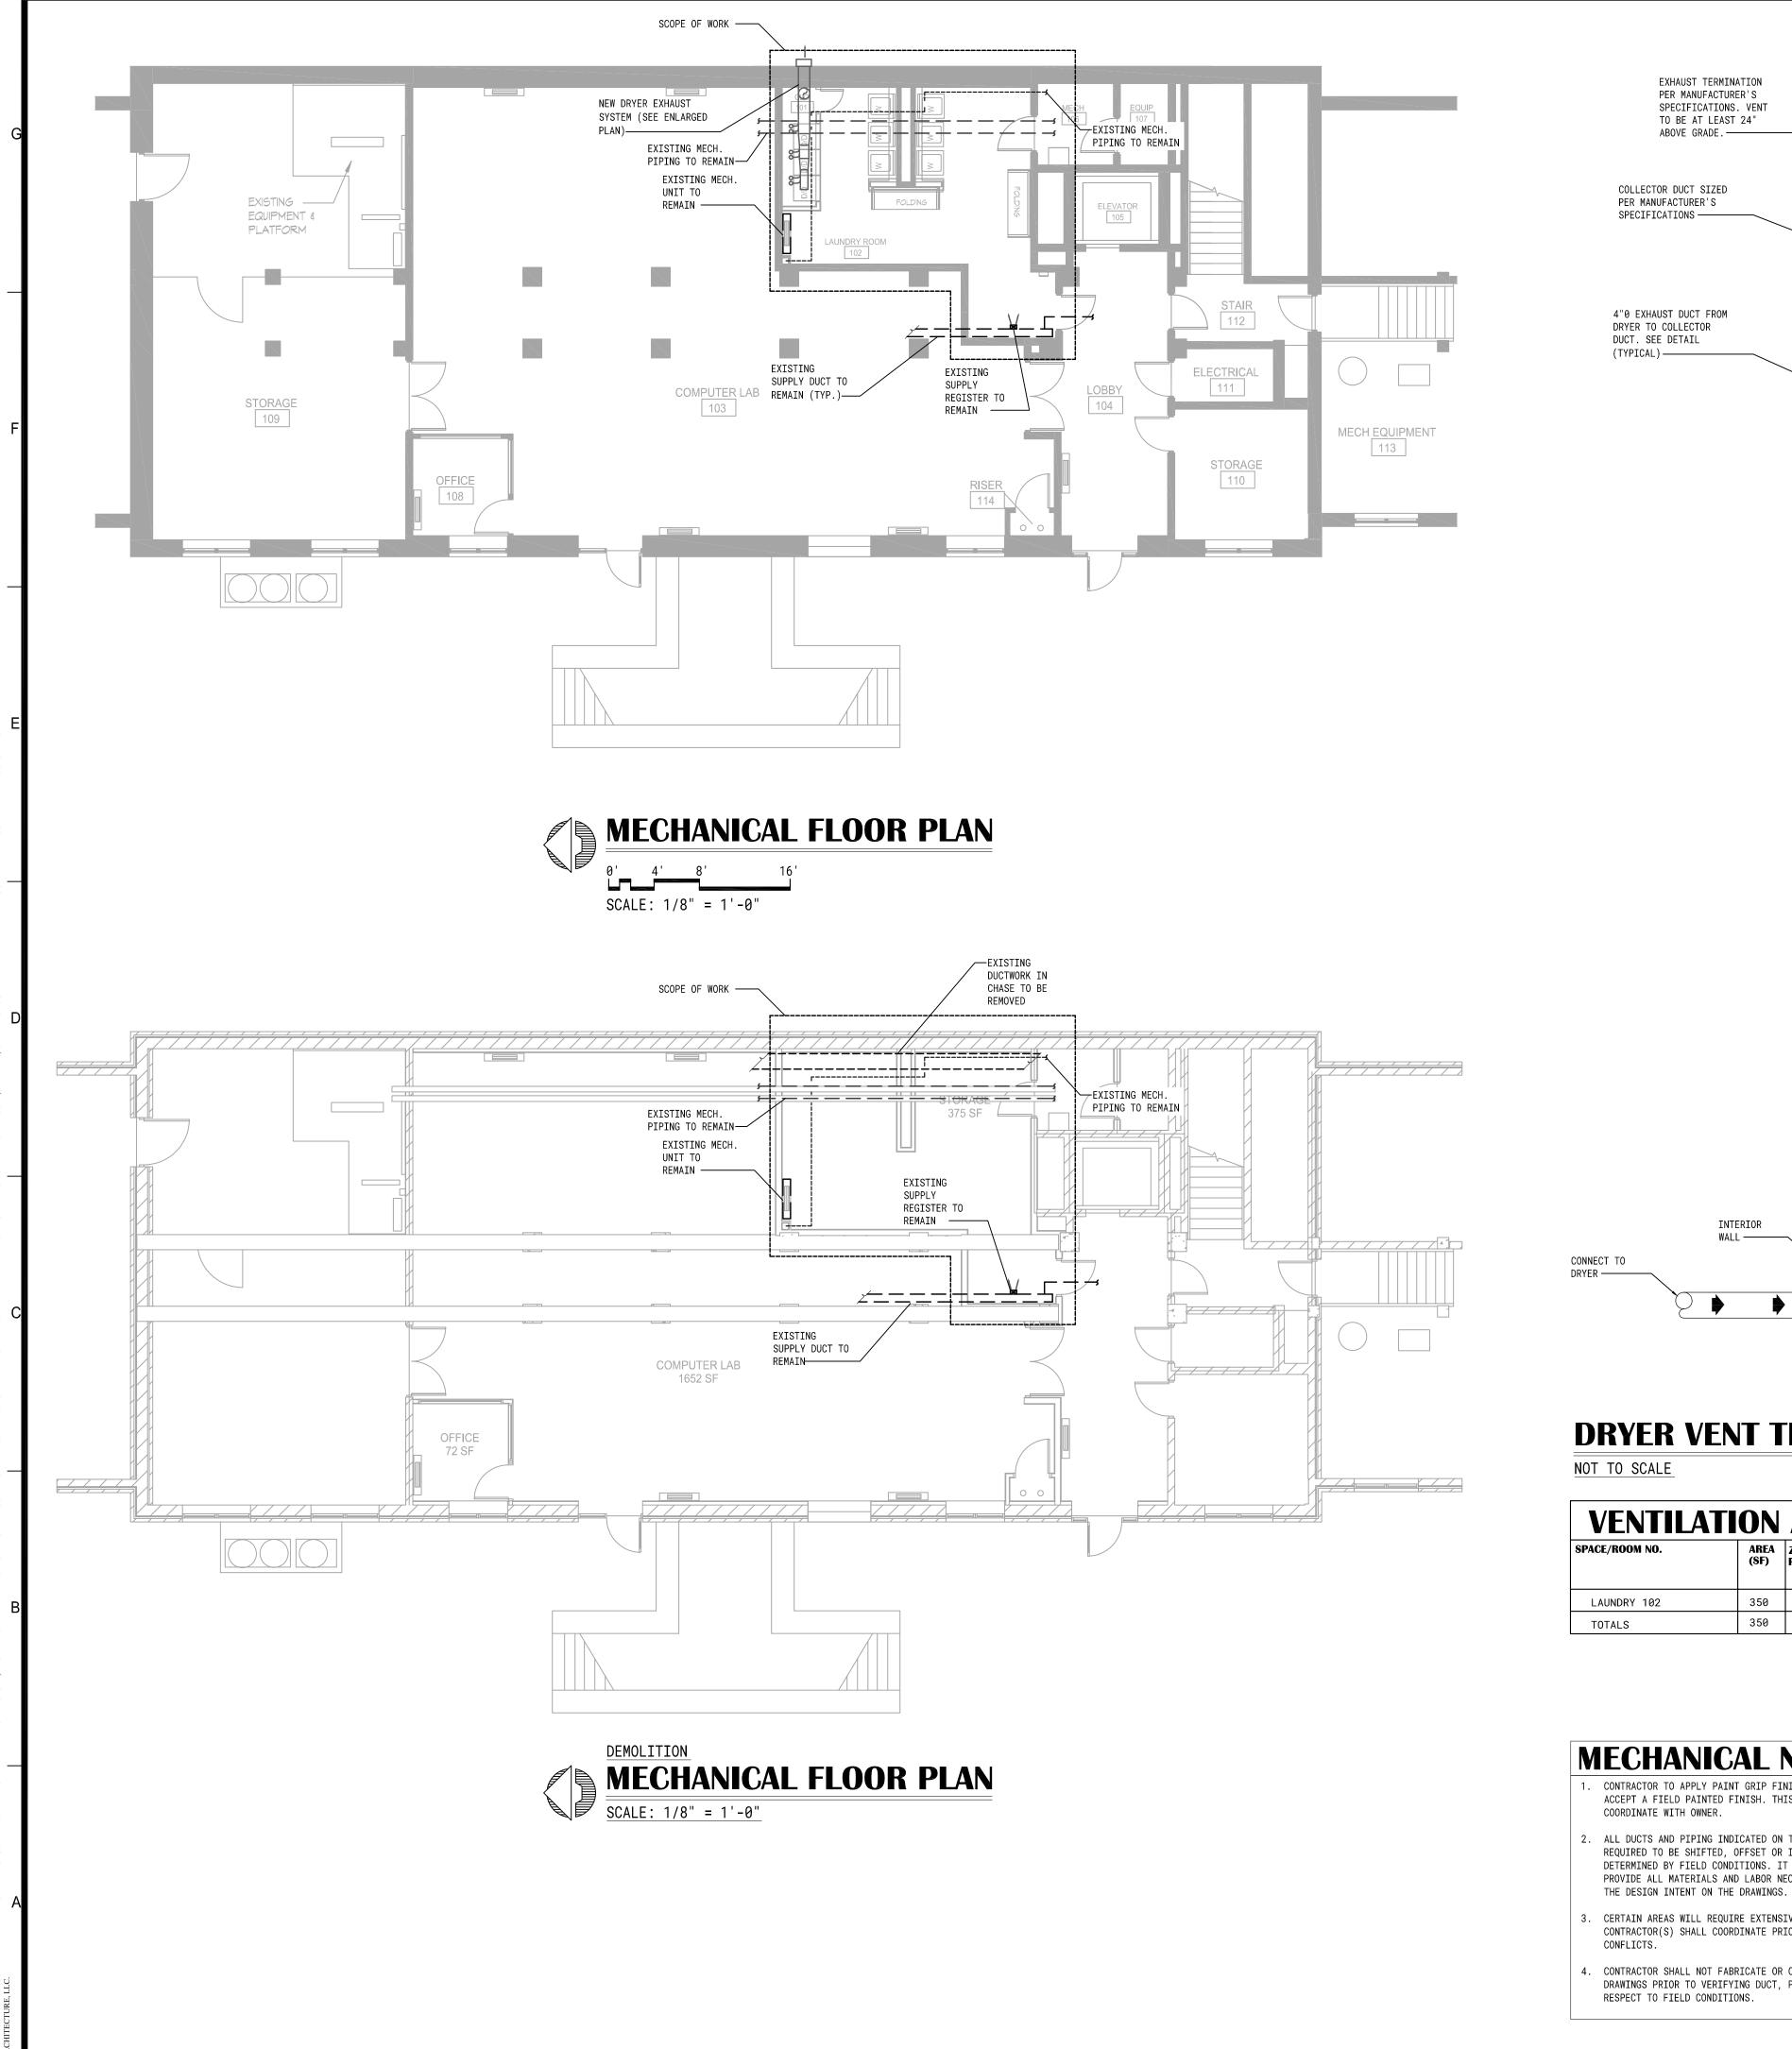
FOR CONSTRUCTION


BAC NUMBER


PROJECT NUMBER 23T-16-00400

REVISIONS

DRAWING TITLE **PLUMBING** FLOOR PLAN



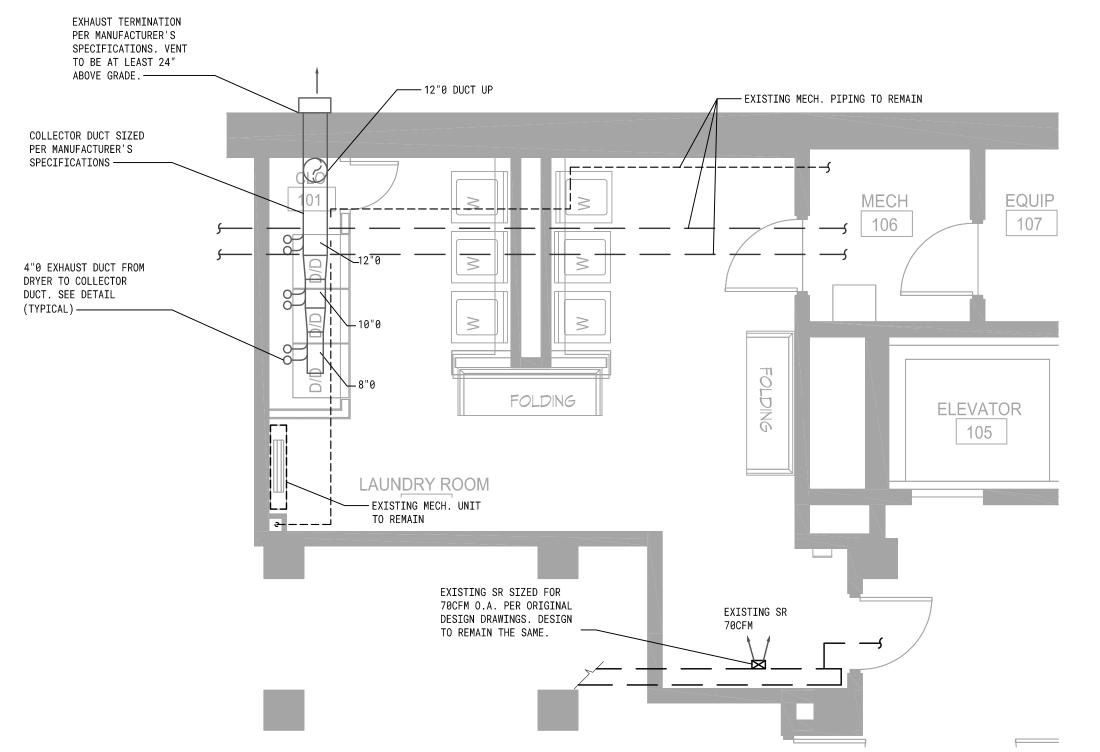

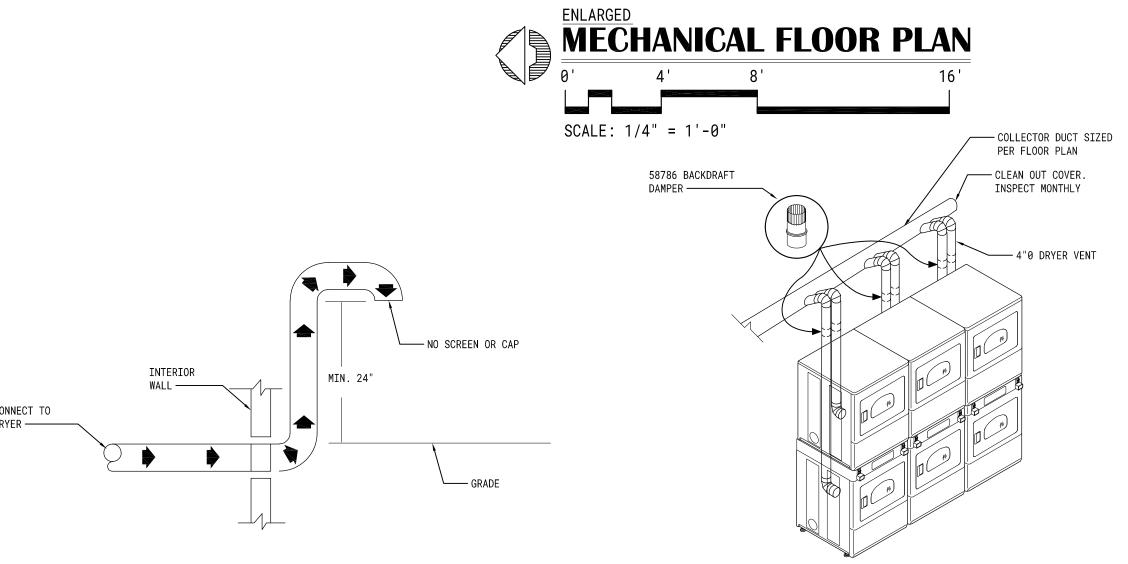

DRYER VENT TERMINATION DETAIL


STACK DRYER VENT DETAIL

NOT TO SCALE

VENTILATI	ON	AIR S	SCHE	DULE	<u>-</u>							
SPACE/ROOM NO.	AREA (SF)	ZONE POPULATION	OUTDOOR AIR (CFM/PERSON)	OUTDOOR AIR (CFM/SF)		ZONE DISTRIBUTION EFFECTIVENESS		PRIMARY	CALCULATED PRIMARY OA FRACTION		OCCUPANT DIVERSITY	REQUIRED OA FLOW (CFM)
LAUNDRY 102	350	4	5	.12	63	1.0	63	225	.10	1	1	63
PALATOT	350							225				63

MECHANICAL NOTES

- CONTRACTOR TO APPLY PAINT GRIP FINISH TO ALL EXPOSED DUCTWORK THAT WILL READILY ACCEPT A FIELD PAINTED FINISH. THIS INCLUDES ALL HANGERS, DRIVES, AND ACCESSORIES.
- ALL DUCTS AND PIPING INDICATED ON THE DRAWINGS ARE DIAGRAMMATIC ONLY. THEY MAY BE REQUIRED TO BE SHIFTED, OFFSET OR INSTALLED HIGH IN BETWEEN THE JOISTS AS DETERMINED BY FIELD CONDITIONS. IT IS THE RESPONSIBILITY OF THE CONTRACTOR TO PROVIDE ALL MATERIALS AND LABOR NECESSARY TO INSTALL THE PIPING AND DUCTS TO MEET
- CERTAIN AREAS WILL REQUIRE EXTENSIVE COORDINATION BETWEEN ALL TRADES. CONTRACTOR(S) SHALL COORDINATE PRIOR/DURING CONSTRUCTION TO ELIMINATE ANY
- CONTRACTOR SHALL NOT FABRICATE OR CONSTRUCT DUCTWORK, PIPING, ETC. FROM THE DRAWINGS PRIOR TO VERIFYING DUCT, PIPING, ETC. CAN BE INSTALLED IN THE FIELD WITH RESPECT TO FIELD CONDITIONS.

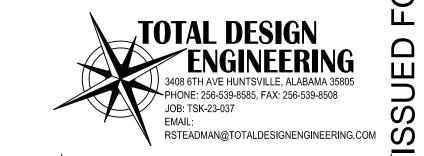

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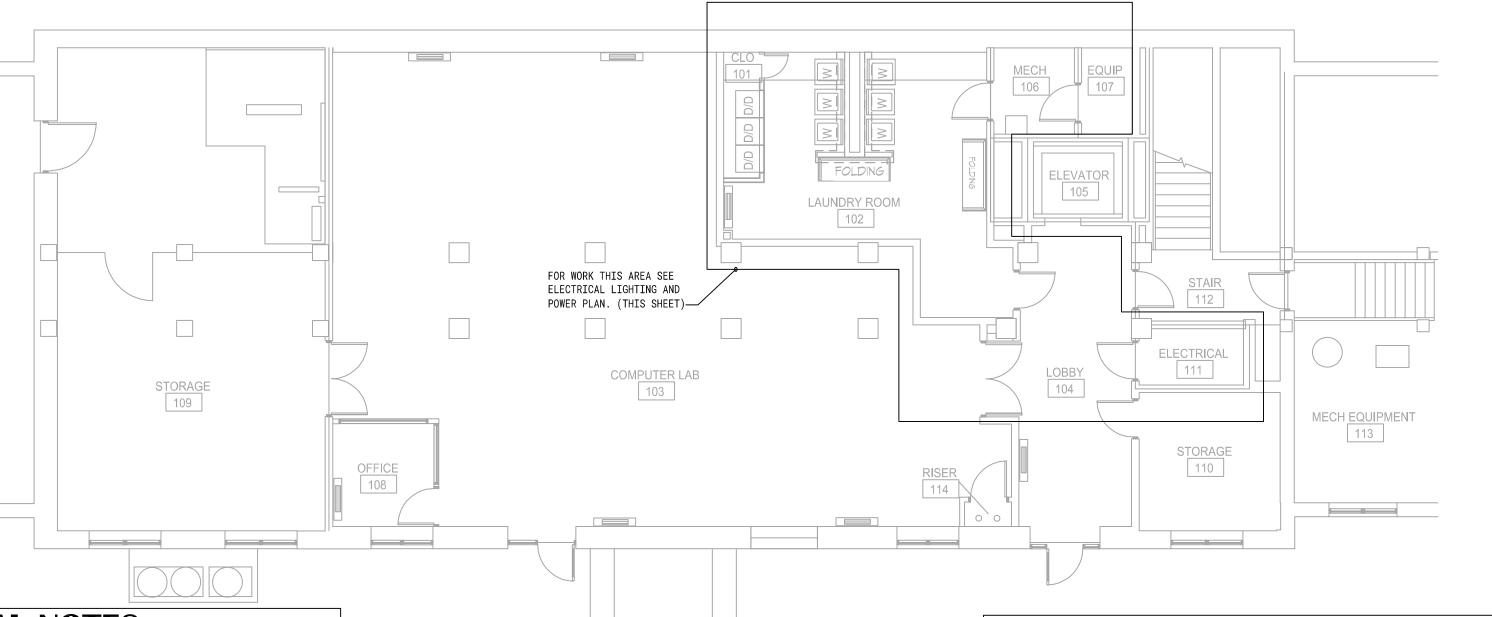
BAC NUMBER

FOR CONSTRUCTION

PROJECT NUMBER 23T-16-00400

REVISIONS

DRAWING TITLE **MECHANICAL FLOOR PLAN**



OVERALL KEY PLAN

PANEL

EXISTING

☐ NF 480/277V 3Ø 18K AIC

☐ NF 480/277V 1Ø 18K AIC

□NQ 208/120V 3Ø 22K AIC

□NQ 240/120V 3Ø 22K AIC

□Q0 240/120V 1Ø 22K AIC

□NEMA 1 -- SURFACE

□NQ 240/120V 1Ø 22K AIC

LIGHTING LEGEND 2X4 LED LAY-IN PANEL
 LUMENS
 COLOR
 WATTS

 5009
 4000K
 39
 LITHONIA LIGHTING CPX 2X4 4000LM 80CRI 40K SWL MIN10 ZT MVOLT LITHONIA LIGHTING CLX L48 4000LM SEF FDL MVOLT 40K 80CRI CLXRW48 NOTES: SUSPEND 10'-0" A.F.F ⊗ थ्रि|EXIT LITHONIA LIGHTING NOTES: SEE FLOOR PLAN FOR CEILING OR WALL MOUNT LED 2 - HEAD EMERGENCY LIGHT LUMENS COLOR WATTS LITHONIA LIGHTING NOTES: SEE FLOOR PLAN FOR CEILING OR WALL MOUNT.

NOTES

REQUIRED.

NOTED ON DRAWING

MECHANICAL PIPING.

SHORT HASH MARKS INDICATE NUMBER OF HOT & SWITCH LEG CONDUCTORS.

SIZE CONDUIT PER N.E.C. LATEST EDITION UNLESS NOTED OTHERWISE.

PROVIDE N.E.C. LATEST EDITION GROUND CONDUCTOR SIZE IN ALL CONDUIT RUNS.

CONDUIT USED FOR AREAS ON BUILDING EXTERIOR SHALL BE RIGID GALVANIZED STEEL

CONDUIT ONLY. UNDERGROUND SHALL BE PVC SCH. 40 OR SCH. 80 UNLESS OTHERWISE

ALL WIRE SHALL BE SOLID COPPER, #12 AWG MINIMUM TYPE THHN/THWN INSULATION

PROVIDE A PULL STRING IN ALL EMPTY DATA OUTLET CONDUITS OF NYLON, BRAIDED

POLYESTER OR PROPYLENE (100# TEST), INSTALLED WITH 12" SLACK AT EACH END OF

INSTALL AN INSULATED EQUIPMENT GROUNDING CONDUCTOR IN EACH RACEWAY OR CONDUIT

SIZE EQUIPMENT GROUNDING CONDUCTOR IN ACCORDANCE WITH N.E.C. TABLE 250.66. CONDUITS SHALL BE ROUTED PARALLEL OR PERPENDICULAR TO WALLS AND/OR CEILING WHEREVER POSSIBLE. ROUTE NO CONDUITS DIRECTLY BENEATH AND PARALLEL TO

VOLTAGE DROP: FOR 20A CIRCUITS OVER 100 FEET AND LESS THAN 175 FEET USE #10 CONDUCTORS. FOR 20A CIRCUITS OVER 175 FEET AND LESS THAN 275 FEET, USE #8

101

PPB-27, 29

/PPB-23,25 [


PPB-11,13

LONG HASH MARKS INDICATE NUMBER OF NEUTRAL CONDUCTORS.

RATED 75°C MIN, 600 VOLTS UNLESS OTHERWISE NOTED. WIRE SIZES LARGER THAN #12 AWG TO BE STRANDED COPPER

ALL CIRCUITS TO INCLUDE GROUND WIRES.

- APPROVED EQUAL BY COLUMBIA, COOPER, OR BELL & MCCOY.
 COORDINATE ALL COLOR OPTIONS WITH OWNER & ARCHITECT, PRIOR TO
- VERIFY EXACT MOUNTING REQUIREMENTS IN FIELD. COORDINATE WITH ARCHITECT & OWNER FOR EXACT ELEVATION PRIOR TO INSTALLATION. VERIFY FINAL LOCATIONS OF LIGHT FIXTURES WITH OWNER PRIOR TO COORDINATE LOCATION OF LIGHT FIXTURES WITH ALL TRADES AS

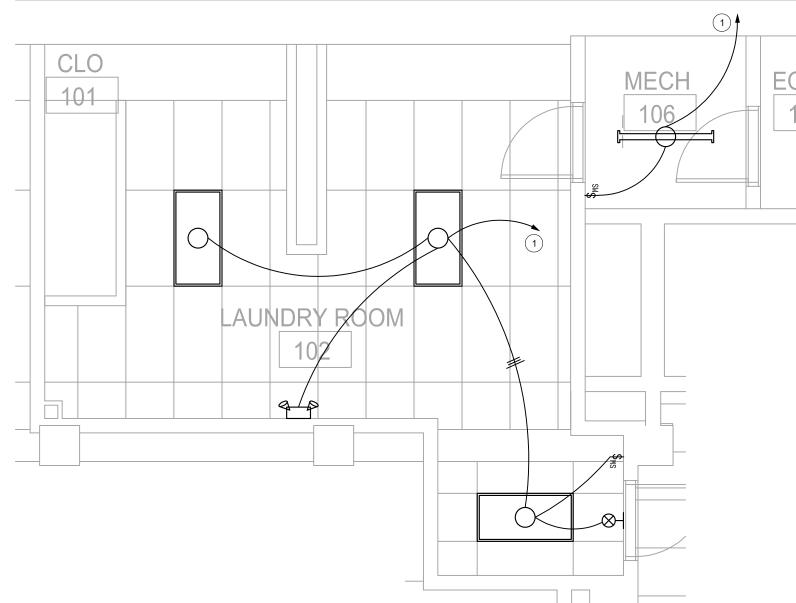

ELECTRICAL LIGHTING PLAN KEYED NOTES:

(1) LIGHTING FIXTURE TO BE CONNECTED BACK TO EXISTING ROOM LIGHTING CIRCUIT



No. 50365 **PROFESSIONAL**


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HEATER PPB-14,16 105



ELECTRICAL NOTES

- ALL NECESSARY NEW ELECTRICAL EQUIPMENT REQUIRED FOR THE WORK PROPOSED SHALL BE FURNISHED AND INSTALLED BY THE CONTRACTOR UNLESS NOTED OTHERWISE AS BEING PROVIDED BY OWNER.
- THE CONTRACTOR SHALL COMPLY WITH ALL REQUIREMENTS OF APPLICABLE FEDERAL, STATE AND LOCAL CODES, ORDINANCES AND REGULATIONS.
- THE CONTRACTOR SHALL OBTAIN AND PAY FOR ALL PERMITS AND CERTIFICATES OF INSPECTION FOR ALL WORK.
- WIRING WHICH PENETRATES FIRE RESISTANT WALLS SHALL BE ENCLOSED IN ELECTRICAL METALLIC TUBING (EMT), UNLESS UL LISTED FOR USE IN THROUGH PENETRATION SYSTEMS. EMT SHALL BE FIRE STOPPED USING APPROVED SEALANTS, CAULKING MATERIALS OR FOAM TO MAINTAIN FIRE RESISTANCE RATING. SEAL ALL ROOF PENETRATIONS WEATHER TIGHT PER LOCAL CODE. REQUEST INSPECTION BEFORE AND AFTER ANY THROUGH FIRE WALL PENETRATIONS.
- METAL CLAD TYPE MC WIRING (WITH GALV. OR ALUMINUM ARMOR) MAY BE USED ABOVE CEILING AREAS PER N.È.C. ARTICLE 330.
- LOCATION OF ELECTRICAL EQUIPMENT IS DIAGRAMMATIC AND SHOWS THE DESIGN INTENT ONLY. CONTRACTOR SHALL COORDINATE WITH PLANS OF ALL OTHER DISCIPLINES AND THEIR INSTALLERS FOR THE EXACT LOCATION OF ALL EQUIPMENT. PULL BOXES OR J-BOXES, THOUGH NOT SHOWN ON PLANS, SHALL BE PROVIDED AND INSTALLED BY THE CONTRACTOR.
- ALL ITEMS INCIDENTAL AND OR REQUIRED TO COMPLETE THE INSTALLATION SHALL BE FURNISHED AND INSTALLED BY THE CONTRACTOR.
- ALL ELECTRICAL EQUIPMENT, INCLUDING CONDUIT AND WIRING SHALL BE NEW AND UNUSED UNLESS NOTED OTHERWISE.
- RECESSED FIXTURES SHALL MAINTAIN A 3" MINIMUM CLEARANCE TO ADJACENT COMBUSTIBLE MATERIALS UNLESS LABELED AS 'IC RATED'. 10. ALL CIRCUIT RUNS SHALL BE IDENTIFIED WITHIN EACH J-BOX WITH THE PROPER CIRCUIT NUMBER/DESCRIPTION OF EACH CIRCUIT ENTERING THE J-BOX. LABEL
- J-BOXES AND CONDUITS WITH PANDUIT CORP. INSTA-CODE PIPE MARKERS OR AN ENGINEER APPROVED EQUIVALENT. . PROVIDE CIRCUIT I.D. ON THE INSIDE OF ALL RECEPTACLES, CONSISTENT WITH
- EXISTING METHODS. 12. FITTINGS TO BE SET SCREW STEEL TYPE UTILIZING AN INSULATED THROAT.
- 13. THE CONTRACTOR SHALL RECORD ON AS-BUILT DRAWINGS ALL SIZES, MATERIAL ELEVATIONS AND/OR LOCATIONS OF ALL ELECTRICAL EQUIPMENT THAT DEVIATE FROM THESE DRAWINGS.
- 4. REPAIR AREAS DAMAGED DURING CONSTRUCTION TO MATCH ADJACENT AREAS WITH RESPECT TO BOTH COLOR AND FINISH.
- IDENTIFY BRANCH CIRCUITS AT THE PANEL AND AT THE LOAD OUTLET, RECEPTACLE AND SWITCH. IDENTIFY THE PURPOSE OF INDIVIDUAL CIRCUIT BREAKERS, AND SAFETY SWITCHES BY MEANS OF NAMEPLATES.
- . MAINTAIN SERVICE CLEARANCE AROUND PANELBOARDS PER N.E.C. ARTICLES 110.26 AND 110.34.
- '. PROVIDE CIRCUIT BREAKERS WITH UL LISTED INTERRUPTING RATINGS (RMS SYMMETRICAL AMPERES) GREATER THAN THE AVAILABLE FAULT CURRENT SHOWN ON ELECTRICAL ONE LINE DIAGRAM OR EQUAL RATING AS ELECTRICAL PANEL.

18. ELECTRICAL CONTRACTOR SHALL BE RESPONSIBLE FOR ELECTRICAL POWER

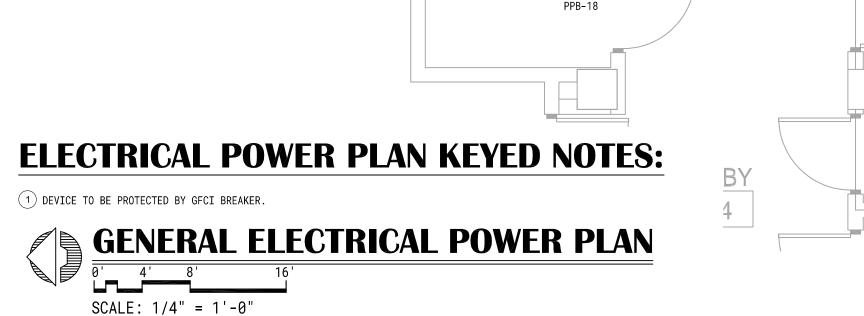- CONNECTIONS TO ALL OWNER FURNISHED FIXTURES. 9. PROVIDE AND CONNECT ALL CONTROL WIRING REQUIRED FOR THE PROPER OPERATION OF THE MECHANICAL SYSTEMS, EXCEPT WHERE SPECIFICALLY SHOWN OTHERWISE ON THE DRAWINGS OR SPECIFIED. REFER TO MECHANICAL DRAWING
- CONTROL DIAGRAMS AND MECHANICAL EQUIP. SHOP DRAWINGS. 20. PROVIDE ALL TEMPORARY POWER AND LIGHTING DURING CONSTRUCTION.
- . AT THE TIME OF SHOP DRAWINGS SUBMITTAL CLEARLY MARK ALL DISCREPANCIES BETWEEN SHOP DRAWINGS AND BID DOCUMENTS.

AE	BBREVIATION	S	
1PH	SINGLE PHASE	GA	GAGE
ЗРН	THREE PHASE	G	GROUND
3W	THREE WIRE	JB0X	JUNCTION BOX
4W	FOUR WIRES	KV	KILOVOLT
A.F.F.	ABOVE FINISHED FLOOR	KVA	KILOVOLT AMPERE
AIC	AMPERE INTERRUPTING CAPACITY	M.B.	MAIN BREAKER
AMP	AMPERE	M.L.O.	MAIN LUG ONLY
BKR	CIRCUIT BREAKER	REC	RECEPTACLE
С	CONDUIT	WP	WEATHERPROOF
CU	COPPER	XFMR	TRANSFORMER
DISC	DISCONNECT SWITCH		
FC	FOOT CANDLE		
GFCI	GROUND FAULT CIRCUIT INTERRUPTER		

Ηг	1	4 5,,,,,,,			_ L						4						
11	INEMA]NEMA	1 FLUSH			- ⊩	 	\vdash				ł						
 	INCHA	JIK .				<u> </u>					<u> </u>		<u> </u>			I	
CIR.	BKR	LABEL		LOAD			LOAD					1.	ABE	=1		BKR	CIR.
2		_,,	LTS	PWR	HVAC	HVAC	PWR	۱ ۱	LTS								[]
1							1.00	3		**W/	ASHE	R				20/1	2
3	40/3	EXISTING LOAD					1.00	3		**W/	ASHE	R				20/1	4
5							1.00	3		**W/	ASHE	R				20/1	6
7	00.40	STACK DRYER-1		2.38			1.00	3		**W/	ASHE	R				20/1	8
9	30/2	STACK DRIER-T		2.38			1.00	3		**W/	ASHE	R				20/1	10
11	00.40	CTACK DDVED 2		2.38			1.00	3		**W/	ASHE	R				20/1	12
13	30/2	STACK DRYER-2		2.38			2.50	3								25/2	14
15		OTAOK DOVED O		2.38]	2.50	a		WATE	ER H	EATER				35/2	16
17	30/2	STACK DRYER-3		2.38			0.54	4		LAUN	NDRY	GENE	RAL	USE	Ξ	20/1	18
19		OTAOK DOVED 4		2.38						SPAF	RE					20/1	20
21	30/2	STACK DRYER-4		2.38						SPAF	RE					20/1	22
19 21 23 25 27	00.40	OTAOK DOVED E		2.38						SPAF	RE					20/1	24
25	30/2	STACK DRYER-5		2.38			Ī			SPAF	RE					20/1	26
27		OTAOK DOVED (2.38						SPAF	RE					20/1	28
29	30/2	STACK DRYER-6		2.38						SPAF	RE					20/1	30
31										SPAF	RE					20/1	32
33	100/3	EXISTING LOAD								SPAF	RE					20/1	34
35										SPAF	RE					20/1	36
37	20/1	SPARE								SPAF	RE					20/1	38
39	20/1	SPARE								SPAF	RE					20/1	40
41	20/1	SPARE	 							SPAF	RE					20/1	42
TOT	TALS		 	28.56			11.5	4								 ТОТ	ALS

CONDUIT & CONDUCTORS

CONDUIT, EXPOSED ON WALL OR CEILING

CONDUIT, CONCEALED IN WALL OR CEILING

HOMERUN TO PANEL, 2 #12 1/2"C AS SHOWN

ONDUIT, INSTALLED BELOW SLABS OR BELOW GRADE

- HOMERUN TO PANEL, 3 #10 3/4"C AS SHOWN

ONE POLE TWO POLE THREE POLE SPARES **GFCI BREAKER REQUIRED

TY AMPS QTY AMPS QTY AMPS

-INDICATES NO. AND SIZE OF CONDUCTORS

-INDICATES HOMERUN TO PANEL

(PANEL LP-B CKT 3 AND 5)

EXISTING 225 AMP 208/120V 3 PHASE PANEL

<u>225</u> AMP □M.B.☒ MLO

LOADS (kVA):

NEW CONN.TOTAL 40.10

40.10

- INDICATES PANEL AND CIRCUIT NO.

ELE	CTRICAL SYMBOLS
\$ _{MS}	MOTION SWITCH, ON/OFF, SINGLE POLE, 125/277 VOLT 20 AMP, SENSOR SWITCH:WSXA OR APPROVED EQUAL.
Ħ	DUPLEX OUTLET, NEMA 5-15R, 125 VOLT. HUBBELL #HBL5262 OR EQUAL.
₩ _{TR}	DUPLEX OUTLET, TAMPER RESISTANT, NEMA 5-15R, 125 VOLT. HUBBELL #HBL5262TR OR EQUAL.
Ħ	SINGLE OUTLET, 240 VOLT, 30 AMP. NEMA 6-30R. HUBBELL #HBL9330 OR EQUAL.
	NON-FUSED DISCONNECT, AMP OR HP RATED, SEE FLOOR PLAN.
2222	ELECTRICAL PANEL (SEE SCHEDULE)
l .	ISH FOR ALL SWITCHES, RECEPTACLES, PLATES AND OTHER DEVICES TO BE COORDINATED WITH OWNER AND HITECT.

MOUNT EMERGENCY LIGHTING 12" BELOW CEILING FOR CEILINGS 10'-0" AND BELOW. MAXIMUM 10'-0" MOUNTING HEIGHT-HORN/STROBE, HORN ONLY, STROBE ONLY (FIRE ALARM) MOUNT 80" A.F.F. OR 6" BELOW FINISHED CEILING, WHICHEVER IS LOWER. — 48"

TOTAL DESIGN ENGINEERING 3408 6TH AVE HUNTSVILLE ALABAMA 35805 PHONE: 256-539-8585, FAX: 256-539-8508 JOB: TSK-23-037 AMINOR@TOTALDESIGNENGINEERING.COM

ELECTRICAL

DRAWING TITLE **ELECTRICAL FLOOR PLAN**

AMU - COUNCIL ASEMENT RENC

ISSUE DATE

ISSUED

6-14-2023

BAC NUMBER

REVISIONS

FOR CONSTRUCTION

PROJECT NUMBER 23T-16-00400

Description

TYP. MOUNT HEIGHTS DETAIL NOT TO SCALE